

The total project cost will be Rs. 80.96 crores

Out of these Rs. 7.36 Crores is the cost of Housing Infrastructure. The following table shows the share of cost between housing infrastructure & Physical Infrastructure.

Table: Cost Breakup between Housing & Infrastructure

SINo.	Component	Cost on Crore
1.	Housing Cost (2000) Dwelling Units)	Rs, 73.60 crore
2.	Infrastructure Cost	Rs, 7.360 crore
Total Rs . 80.96 crore		

Key Findings—Slums under Siliguri Municipal Corporation

4. Housing :

Individual houses, which are katcha / temporary in nature and in dilapidated condition, have been identified from the survey and proposed for provision of Housing. In Siliguri MC, the authority has identified such 2000 Units for 2015-16, which needs for reconstruction. The implementation is restricted to slum pockets only. The target group of this scheme is mainly from BPL & EWS categories. The houses under the scheme are pucca type. The walls are made of brick and the roof is made of RCC.

4. Cement Concrete Road:

Existing roads in slum of Siliguri MC are not so good. Maximum Roads are narrow and kutchha. So the monsoon rains creates water logging problem in low lying areas of slum. For 2000 nos. of beneficiaries , 10821 m of Roads is proposed to be constructed of 2.5 m wide in financial year 2015-16 including Slums & Non Slums.

4. Drains :

In slum areas too, open surface drains are in existence. However, there are areas, which have not yet been covered under Drainage network. The slums have 5 Km surface drain total. For 2000 nos. of beneficiaries , 12809 m of Drains is proposed to be constructed in financial year 2015-16 including Slums & Non Slums.

Environment Impact Assessment

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IMPACT & REMEDIES		
1.	Utilization of alternative material Characteristics and availability of alternative material	Locally available bricks etc. will be used.
2.	Rehabilitation of water bodies & measures for maintaining surface runoff smoothly	No water body is affected by the alignment of road. The road side open C. C. / Brick masonry drains have been provided for free flow of storm water.
3.	Measures for Erosion Control	Not applicable for the slum area.
4.	Conservation of Topsoil a. Extent of loss of topsoil b. Area requirement for topsoil conservation c. Inclusion of conservation of topsoil d.	Not applicable for the slum area.
5.	Impact on Heritage & Culture a. Identification of locally significant cultural properties b. Assessment of likely impacts on each cultural property due to project implementation c. Possible measures for avoidance i) Identification of alternative routes ii) Relocation of Culture property in consultation with the local community iii) Common Property iv)	Question does not arise.
6.	Location of Natural Habitants	It will not be disturbed
7.	Construction of site office / Camp	Temporary construction of camp / office shall be established by contractor and since the project is small and scattered, the temporary impact on environment for Construction Camp / office at the time of execution of work is negligible.
8.	Quarrying of Materials a. Sourcing of materials from quarries b. Lead from various existing quarries c. Adequacy of material for the project in these quarries	The construction materials require for the project shall be procured from : a) Stone metal : from the existing. b) Bricks : From the existing brick fields nearby the project site. c) Sand : From the nearest source. All the materials are sufficiently available.
9.	Water Requirement; Identification of potential sources of water	Water required for the construction of work will be available from ground water. There is no scarcity of water in the region.
10.	Location of Waste Water Disposal : a. Location for disposal of waste water b. Outfalls locations for longitudinal drains i) Outfall level and back flow	The surface drain have been proposed in the slum for disposal of waste water. Natural slope of the ground will be maintained for waterways for discharge of surface runoff. No possibility of back flow except in the case of heavy flood.

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	ii) The outfall is in natural stream; measures shall be taken to prevent sediment into the stream.	The storm water drain of the slums will discharge the water to the main high drain of the town.
11.	Air Pollution during construction work	Work shall be carried out by equipments like concrete mixer machine vibrator etc. at this time of concreting work only for which air pollution will be negligible.
12.	Identify locations susceptible to induced development	Locations vulnerable to induced development: In such location the Municipality has committed not to allow building construction activity. a. Lands within 50 m of junctions b. Agricultural lands with enforce restriction on building activity on either side of road. Stretches within 100m of worship places, weekly fairs and locations of community mass gatherings.
13.	Roles and responsibilities of municipality in regulating development	The municipality shall lay down restrictions on building activities along the by-pass roads : 1. Municipality will enforce restriction on building activity on either side of road. 2. Development of Residential sites outside Existing Settlement. Appropriate measure towards the removal of encroachments onto the public land to be taken.
14.	Traffic Congestion and related air & noise pollution	As the road passes through the slum area of the town and two wheelers, Three wheelers, light vehicle will move hence there will not be any traffic congestion, related air & noise pollution.
15.	Opportunity in economic activities due to ease of transportation system	The benefits due to this project are : 1. Generation of Man days 2. Improvement in Household or population sector i.e. Improvement of personal health, hygiene, socio- economic condition, education etc.

Sector wise Monitoring and Implementation Plan

Background

A strong implementation plan and administration frame work for implementation of the identified projects that require strengthening of the Municipal Corporation and evolution of a Community Structure.

Accurate assessment of investment requirements and devising a suitable financing strategy are the key components of any sustainable slum rehabilitation program.

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Implementing bodies must recognize and measure the various costs of developing infrastructure and housing, including the costs for subsequent maintenance. As the scheme is a collaborative effort of multiple stakeholders, with a few of them contributing financially as well, it is important to estimate the required capital expenditure for developing the infrastructure and improving the housing stock as accurately as possible.


National Level

PMAY Mission Directorate

There shall be a PMAY Mission Directorate under the charge of a Joint Secretary under the Ministry of Housing and Urban Poverty Alleviation, supported by staff and a Programme Management Unit with experts having expertise in the areas of survey and statistics, computerization and MIS, GIS, Planning, Project engineering, Social development, Monitoring and evaluation etc. for ensuring effective co-ordination with State Governments for expeditious processing of the State Slum-free Po As and project proposals and providing hand holding support to States/UTs.

State PMAY Mission Director

The State Level Nodal Agency for PMAY/SUDA, West Bengal will have coordination of all scheme and reform-related activities more than one department handling Urban development, Local self government, and Housing. SLNA. The Mission Directorate supported by a team of dedicated professionals having expertise in the fields of GIS, MIS, town planning, community development, project engineering, capacity development etc

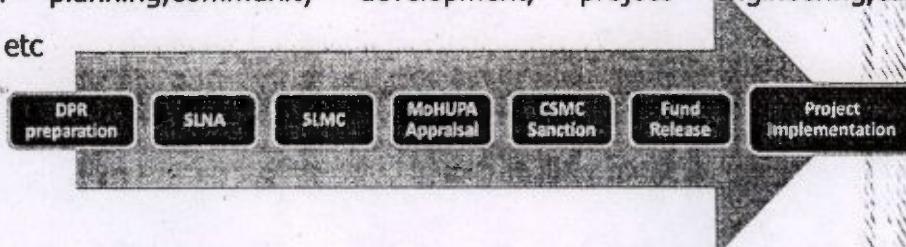

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The Municipality shall act as the implementation agency for the project. Keeping in mind the criticality of the project, a dedicated '**Bustee Works Management Committee (BWMC)**' has been setup for implementation and operation & maintenance (O&M) of the proposed infrastructure under the scheme.

The BWMC will have representatives of local councillor, Chairman-in-Council, municipal engineers,

Town project officer, community organizers and member from the local

slum dwellers. Some of the responsibilities of BWM Care listed below:

- i. Delineation of poverty pockets in this town to execute the scheme.
- ii. Recruitment of community organizers
- iii. Guiding and assisting the community organizer to form neighbourhood group (NHG) and for identification of RCVs.
- iv. Formation of NHCs and CDs.
- v. Constitution of town level planning and monitoring committee (TLMC).
- vi. Liaison with CMOH and other concerned district level officers and NGOs for conference.
- vii. Regular contact with SUDA and Department of Municipal Affairs.
- viii. Convening meeting of TLMC to take stock of programme implementation and convergence.
- ix. Dovetail all poverty alleviation programmes with IHSDP.
- x. Obtain regular feedback from CDS and send the required monthly progress report to

SUDA by the end of first week of the next month in the prescribed MIS format.

Participation through Beneficiary committees

People's participation in municipal planning and development is critical and shall be ensured

Through of Ward Committees in each ward irrespective of their population and size.

The Ward Committee Rules have also been framed in such a

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involvement of the members of the Ward Committees in the overall municipal administration and resource mobilization. The Ward Committee created especially for the purpose of PMAY will be headed by the Councillor of the Ward, who would in turn submit there port of progress to BWMC.

Some of the responsibilities the Ward Committee will be:

- i. Supervision of the physical progress of the work under the project
- ii. Designating in-charge, who would be held responsible for individual scheme under the project
- iii. Collecting user charges for operation and maintenance(O&M) activities
- iv. Ensuring proper maintenance of each of the assets that is created under the project

Participation through Community Based Organization

Participation of poor families in planning and implementation of slum level Basic Infrastructure Development as well as Socio-Economic Development has been ensured through formation of Community Based Organization. The Ward Committee will also have representative of weaker community. Similar structure have also been involved by the municipalities in providing civic services like conservancy services, maintenance of street light, etc. municipal administration and resource mobilization.

However, basic guide lines, which will be followed in implementation of the projects, are been laid down below:

Monitoring & Evaluation

PMAY will be monitored at three levels: City, State and Government of India. In particular,

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- Ministry of Housing and Urban Poverty Alleviation will periodically monitor the scheme.
- State Nodal Agency would send Quarterly Progress Report (on-line) to the Ministry of Housing and Urban Poverty Alleviation.
- Upon completion of a project, the State Nodal Agency, through the State

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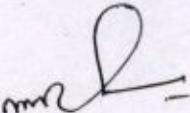
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Government, would submit completion report to the Central Government.

- Central Sanctioning-cum-Monitoring Committee will meet as often as required to sanction
 - And review/monitor the progress of projects sanctioned under the Mission.
- States/Cities will be facilitated through independent quality control/assurance/thirdparty teams at various levels that may be outsourced to specialized/technical agencies.
- Monitoring of projects by States/Urban Local Bodies by conducting Social Audit in conform it with guideline to be prescribed, right from the stage of project preparation.
- The processes of implementation will be monitored by under taking concurrent evaluation
 - Through reputed independent institutions to ensure that corrections to distortions, oversights or short coming scan be made in time.

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WORK AND COST SUMMARY - NON SLUM WISE DETAILS

Slum No.	Ward No.	Name of Area	HOUSING				PHYSICAL INFRASTRUCTURE				Grand Total (Rs. In Lakh)	
			Dwelling Units (@ Rs. 3,60314 Lakh/ each)		Leach Pit (@ Rs.0.07688 Lakh/ each)		Drainage (M) (Rs.2297.00/M) (Section -300x300)		Concrete Roads (@ Rs. 4097.00/M)			
			Qty.	Amt.	Qty.	Amt.	Qty.	Amt.	Qty.	Amt.		
1 1	DIESEL COLONY	21	75.67	21	1.61	135	3.09	113	4.64	85.01		
3 2	DESHPRIYA SARANI	4	14.41	4	0.31	26	0.59	22	0.88	16.19		
4 2	SOUTH BAGHAJATIN COLONY	2	6.92	2	0.15	12	0.28	10	0.42	7.77		
5 5	NATUN PARA COLONY	41	146.43	41	3.12	260	5.98	237	9.72	165.25		
6 9	S.P.MUKHERJEE ROAD,KHALPARA	6	21.33	6	0.46	38	0.87	32	1.31	23.96		
7 12	TILOK ROAD	6	23.06	6	0.49	41	0.94	34	1.41	25.91		
8 13	ASHRAMPARA	9	31.13	9	0.66	55	1.27	47	1.91	34.97		
9 15	HAKIMPARA	14	49.00	14	1.05	87	2.00	83	3.40	65.45		
10 16	HAKIM PARA SILIGURI	8	28.83	8	0.61	51	1.18	43	1.77	32.38		
11 17	COLLEGE PARA	4	16.14	4	0.34	29	0.66	24	0.99	18.13		
12 18	SUBHAS PALLY	3	9.22	3	0.20	16	0.38	14	0.57	10.36		
13 19	SUBHASH NAGAR COLONY RABINDRA	6	20.18	6	0.43	36	0.82	30	1.24	22.67		
14 21	NAGAR (SILIGURI)	18	63.42	18	1.35	113	2.59	95	3.88	71.24		
15 22	1 NO DABGRAM	37	134.33	37	2.87	239	5.49	201	8.23	150.90		
16 24	BHARAT NAGAR	4	14.99	4	0.32	27	0.61	22	0.92	16.84		
17 24	GURU SADAY DUTTA ROAD	21	74.95	21	1.60	133	3.06	112	4.59	84.20		
18 24	SHRAMICK NAGAR	13	48.43	13	1.03	86	1.98	72	2.97	54.40		
19 24	SOUTH BHARAT NAGAR	14	50.16	14	1.07	89	2.05	75	3.07	56.35		
20 25	HARISHABHA RD	12	42.66	12	0.91	76	1.74	64	2.61	47.93		
21 26	MILLAN PALLY VIDYAPITH	10	36.03	10	0.77	64	1.47	54	2.21	40.48		
22 27	ROAD,DESHBAN DHU PARA	4	15.57	4	0.33	28	0.64	23	0.95	17.49		
23 28	DESH BANDHU PARA	16	59.38	16	1.27	106	2.42	98	4.00	67.07		
24 39	HAIDER PARA	16	58.23	16	1.24	104	2.38	96	3.92	65.77		
25 40	HAIDER PARA	17	59.96	17	1.28	107	2.45	90	3.67	67.36		
26 45	MALLAGURI	7	23.64	7	0.50	42	0.97	35	1.45	26.55		
27 46	CHAMPASARI ANCHAL	14	49.00	14	1.05	87	2.00	73	3.00	55.05		
28 46	S.NARMADA BAGAN	3	9.80	3	0.21	17	0.40	15	0.60	11.01		
29 46	VIDYA NAGAR	4	16.14	4	0.34	29	0.66	27	1.12	18.27		
30 47	RAMKRISHNA COLONY	22	79.27	22	1.69	141	3.24	119	4.86	89.05		
	TOTAL	355	1278	355	27	2273	52	1960	80	1438		

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WORK AND COST SUMMARY - SLUM WISE DETAILS

Slum No.	Ward No.	Name of Slum	Area SqKm	HOUSING				PHYSICAL INFRASTRUCTURE				Grand Total (Rs. In Lakh)
				Dwelling Units (@ Rs. 3,60314 Lakh/ each)		Leach Pit (@ Rs. 0.07686 Lakh/ each)		Drainage (M) (Rs. 2297.00/M) (Section -300x300)		Concrete Roads (@ Rs. 4097.00/M)		
Qty.	Amt.	Qty.	Amt.	Qty.	Amt.	Qty.	Amt.	Qty.	Amt.	Qty.	Amt.	
1 1	B.R.I. COLONY	0.0010	7	26.59		7	0.57	47	1.09	40	1.63	29.87
2 1	DHARAMO NAGAR	0.0930	5	17.46		5	0.37	31	0.71	26	1.07	19.62
3 1	KSHUDIRAM COLONY 1	0.0090	5	16.68		5	0.36	30	0.68	25	1.02	18.74
4 1	PANCHANAN COLLONY 2	0.0350	23	82.37		23	1.76	146	3.36	123	5.05	92.53
5 1	PANCHANAN COLONY(1)	0.0490	21	75.59		21	1.61	134	3.09	113	4.63	84.92
6 1	RAJENDRA NAGAR	0.0040	80	287.76		80	6.14	512	11.75	430	17.63	323.28
7 1	RATAN LAL BASTEE	0.0250	8	27.89		8	0.59	50	1.14	42	1.71	31.33
8 1	SOUTH AMBEDKAR COLONY	0.0130	28	100.89		28	2.15	179	4.12	151	6.18	113.34
9 1	SURYASEN COLONY(1)	0.1430	13	46.84		13	1.00	83	1.91	70	2.87	52.62
10 2	BAGHAJATIN COLONY	0.0090	25	90.08		25	1.92	160	3.68	135	5.52	101.20
11 2	EAST BAGHAJATIN COLONY	0.0270	3	10.95		3	0.23	19	0.45	16	0.67	12.30
12 2	NEPALI BASTEE/B.B.D. COLONY	0.0540	13	45.87		13	0.98	82	1.87	69	2.81	51.54
13 2	PURBANCHAL/D HUP COLONY	0.0090	5	16.94		5	0.36	30	0.69	25	1.04	19.03
14 3	GURUNG BASTEE(DURGA NAGAR)	0.0190	14	50.44		14	1.08	90	2.06	75	3.09	56.67
15 3	PRADHAN NAGAR(JYOTIR MOY CLUB)	0.0200	4	14.41		4	0.31	26	0.59	22	0.88	16.19
16 3	SOUTH BAGHAJATIN COLONY	0.0060	10	34.93		10	0.75	62	1.43	52	2.14	39.24
17 4	ADARSHA NAGAR COLONY	0.0060	29	105.04		29	2.24	187	4.29	157	6.43	118.01
18 4	DURGANAGAR COLONY	0.0020	5	17.72		5	0.38	32	0.72	27	1.09	19.91
19 4	JYOTI NAGAR COLONY	0.0090	62	223.90		62	4.78	398	9.14	335	13.72	251.53
20 4	TUMAL PARA	0.0330	23	83.41		23	1.78	148	3.41	125	5.11	93.70
21 5	GANGA NAGAR	0.0020	63	227.55		63	4.85	405	9.29	340	13.94	255.63
22 5	SANTOSHI NAGAR	0.0190	1	3.65		1	0.08	6	0.15	5	0.22	4.10
23 6	DARBHANGA TOLA,FAKIR TOLA	0.0310	11	38.58		11	0.82	69	1.58	58	2.36	43.34
24 7	SWAMI NAGAR	0.0040	7	24.50		7	0.52	44	1.00	37	1.50	27.53
25 7	VIVEKANANDA COLONY	0.0010	11	38.06		11	0.81	68	1.55	57	2.33	42.75
26 8	M.R COMPOUND	0.0020	8	27.89		8	0.59	50	1.14	42	1.71	31.33

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Slum No.	Ward No.	Name of Slum	Area SqKm	HOUSING				PHYSICAL INFRASTRUCTURE						Grand Total (Rs. In Lakh)	
				Dwelling Units (@ Rs.3,60314 Lakh/ each)		Leach Pit (@ Rs.0.07886 Lakh/ each)		Drainage (M) (Rs.2297.00/M) (Section -300x300)		Concrete Roads (@ Rs. 4097.00/M)					
				Qty.	Amt.	Qty.	Amt.	Qty.	Amt.	Qty.	Amt.				
27	10	VIDYA CHAKRO COLONY	0.0010	10	34.93	10	0.75	62	1.43	52	2.14	39.24			
28	14	HARIJAN BASTEE(ASRAM PARA)	0.0120	4	13.55	4	0.29	24	0.55	20	0.83	15.23			
29	18	LICHU BAGAN COLONY	0.0010	7	24.76	7	0.53	44	1.01	37	1.52	27.82			
30	18	PROMAD NAGAR	0.0130	5	16.68	5	0.36	30	0.68	25	1.02	18.74			
31	18	SHRABAN NAGAR	0.0040	1	3.65	1	0.08	6	0.15	5	0.22	4.10			
32	20	DURGA DAS COLONY	0.0170	10	34.67	10	0.74	62	1.42	52	2.12	38.95			
33	20	FULESWARI UNNAYAN COLONY	0.0160	9	31.54	9	0.67	56	1.29	47	1.93	35.43			
34	20	RAM MOHAN COLONY	0.0240	14	50.57	14	1.08	90	2.07	76	3.10	56.81			
35	20	SHRABAN NAGAR COLONY	0.0110	1	4.69	1	0.10	8	0.19	7	0.29	5.27			
36	23	UDAYAN COLONY	0.0090	21	76.63	21	1.63	136	3.13	115	4.69	86.09			
37	29	FULESWARI COLONY	0.1020	9	33.62	9	0.72	60	1.37	50	2.06	37.77			
38	29	SAMITI COLONY	0.0040	2	5.47	2	0.12	10	0.22	8	0.34	6.15			
39	30	DESBANDHU COLONY	0.0020	9	31.02	9	0.66	55	1.27	46	1.90	34.85			
40	31	NOUKA GHAT	0.0490	26	92.01	26	1.96	164	3.76	138	5.64	103.37			
41	31	SHEETALA PARA	0.0370	19	69.07	19	1.47	123	2.82	103	4.23	77.60			
42	32	JYOTIRMOY COLONY	0.0570	51	182.46	51	3.89	324	7.45	273	11.18	204.98			
43	33	SUKANTA PALLY (HATATH COLONY)	0.0280	25	89.40	25	1.91	159	3.65	134	5.48	100.44			
44	33	SURY SEN COLONY	0.0010	9	32.58	9	0.70	58	1.33	49	2.00	36.60			
45	34	BHAKTI NAGAR	0.0080	10	35.19	10	0.75	63	1.44	53	2.16	39.53			
46	34	SURYA SEN COLONY (BLOCK-D)	0.0330	13	45.61	13	0.97	81	1.86	68	2.79	51.24			
47	34	SURYASEN COLONY(BLOCK-E-2-A)	0.0710	55	196.79	55	4.20	350	8.04	294	12.05	221.08			
48	35	BHAKTI NAGAR-A	0.0150	12	43.27	12	0.92	77	1.77	65	2.65	48.61			
49	35	BHAKTI NAGAR-B	0.0240	7	25.28	7	0.54	45	1.03	38	1.55	28.40			
50	35	SAHID COLONY-B	0.0250	4	14.08	4	0.30	25	0.57	21	0.86	15.81			
51	35	SAHID COLONY-D	0.0110	5	19.03	5	0.41	34	0.78	28	1.17	21.38			
52	36	NERANJAN NAGAR COLONY	0.0290	22	79.27	22	1.69	141	3.24	119	4.86	89.05			
53	36	NETAJI COLONY	0.0190	30	108.43	30	2.31	193	4.43	162	6.64	121.81			
54	36	NETAJI PARA	0.0010	20	72.46	20	1.55	129	2.96	108	4.44	81.40			

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Slum No.	Ward No.	Name of Slum	Area SqKm	HOUSING				PHYSICAL INFRASTRUCTURE				Grand Total (Rs. In Lakh)	
				Dwelling Units (@ Rs.3,60314 Lakh/ each)		Leach Pit (@ Rs.0.07686 Lakh/ each)		Drainage (M) (Rs.2297.00/M) (Section -300x300)		Concrete Roads (@ Rs. 4997.00/M)			
				Qty.	Amt.	Qty.	Amt.	Qty.	Amt.	Qty.	Amt.		
55	36	NIRANJAN NAGAR	0.0360	31	111.30	31	2.37	198	4.55	166	6.82	125.04	
56	36	SANTI NAGAR	0.0650	4	13.55	4	0.29	24	0.55	20	0.83	15.23	
57	36	SOUTH SANTI NAGAR	0.0750	15	53.69	15	1.15	95	2.19	80	3.29	60.32	
58	37	CHAYAN PARA	0.1010	23	82.87	23	1.77	147	3.38	124	5.08	93.10	
59	37	CHAYAN PARA COLONY	0.0280	24	86.48	24	1.84	154	3.53	129	5.30	97.15	
60	37	NETAJI COLONY	0.0070	11	39.63	11	0.85	70	1.62	59	2.43	44.53	
61	37	NIRANJAN NAGAR COLONY	0.0450	30	108.09	30	2.31	192	4.41	162	6.62	121.44	
62	37	SARADA PALLY	0.0010	2	7.82	2	0.17	14	0.32	12	0.48	8.78	
63	38	SUKANTA NAGAR	0.1030	21	75.59	21	1.61	134	3.09	113	4.63	84.92	
64	39	SHIBRAM PALLY	0.0180	8	27.89	8	0.59	50	1.14	42	1.71	31.33	
65	40	DURGA NAGAR COLONY	0.0100	22	78.46	22	1.67	139	3.20	117	4.81	88.14	
66	40	GORUNGA PALLY COLONY	0.0050	6	22.16	6	0.47	39	0.90	33	1.36	24.89	
67	40	HARE KRISHNA COLONY	0.0120	11	40.14	11	0.86	71	1.64	60	2.46	45.09	
68	40	JYOTI NAGAR	0.0050	53	191.58	53	4.09	341	7.82	286	11.74	215.22	
69	40	KSHUDIRAM COLONY	0.0120	16	57.08	16	1.22	101	2.33	85	3.50	64.13	
70	41	BAIKUNTHA PALLY	0.0240	10	35.19	10	0.75	83	1.44	53	2.16	39.53	
71	41	BANKIM NAGAR	0.0180	7	23.98	7	0.51	43	0.98	36	1.47	26.94	
72	41	SHASTRI NAGAR	0.0180	17	62.82	17	1.34	112	2.57	94	3.85	70.57	
73	42	BHUPENDRA NAGAR (VIVEKANANDA COLONY)	0.0490	40	144.92	40	3.09	258	5.92	217	8.88	162.81	
74	42	CHAYAN PARA & SARBA PALLY	0.0010	26	92.53	26	1.97	165	3.78	138	5.67	103.95	
75	42	PASCHIM SALUGARA	0.0340	4	16.16	4	0.34	29	0.66	24	0.99	18.15	
76	42	SAROJINI PALLY & PRAMOD NAGAR	0.0010	13	47.70	13	1.02	85	1.95	71	2.92	53.59	
77	43	DADABHAI COLONY	0.0290	1	2.61	1	0.06	5	0.11	4	0.16	2.93	
78	43	GANDHI NAGAR	0.0160	7	25.54	7	0.54	45	1.04	38	1.56	28.70	
79	43	LOWER BHANU NAGAR	0.0530	22	78.20	22	1.67	139	3.19	117	4.79	87.85	
80	43	PASWAN BASTEE	0.0100	6	21.11	6	0.45	38	0.86	32	1.29	23.72	
81	43	PRAKSH NAGAR	0.0400	17	60.47	17	1.29	108	2.47	90	3.70	67.93	
82	44	DASHRATH PALLY	0.0630	21	75.85	21	1.62	135	3.10	113	4.65	85.21	
83	44	JANATA NAGAR	0.0220	15	54.48	15	1.16	97	2.22	81	3.34	61.20	
84	44	PARESH NAGAR	0.0370	11	40.92	11	0.87	73	1.67	61	2.51	45.97	

P.B. *cm* *D*
 Executive Engineer
 Siliguri Municipal Corporation
 Siliguri

C *Commissioner*
 Siliguri Municipal Corporation
Cllr.

Slum No.	Ward No.	Name of Slum	Area SqKm	HOUSING				PHYSICAL INFRASTRUCTURE				Grand Total (Rs. In Lakh)
				Dwelling Units (@ Rs.3,60314 Lakh/ each)		Leach Pit (@ Rs.0.07656 Lakh/ each)		Drainage (M) (Rs.2297.00/M) (Section -300x300)		Concrete Roads (@ Rs.4097.00/M)		
Qty.	Amt.	Qty.	Amt.	Qty.	Amt.	Qty.	Amt.	Qty.	Amt.	Qty.	Amt.	
85 44	VIDYASHAKRA COLONY	0.0010	22	78.72	22	1.68	140	3.21	118	4.82	88.43	
86 45	BAGHAJATIN COLONY	0.0690	42	151.33	42	3.23	269	6.18	226	9.27	170.01	
87 45	DURGA GURI COLONY	0.0150	10	36.03	10	0.77	64	1.47	54	2.21	40.48	
88 45	MALLAGURI	0.0630	10	36.03	10	0.77	64	1.47	54	2.21	40.48	
89 46	ANANDA MAYEE COLONY	0.0030	6	22.94	6	0.49	41	0.94	34	1.41	25.77	
90 46	GANESH GHOSH COLONY	0.0110	9	34.15	9	0.73	61	1.39	51	2.09	38.36	
91 46	NAYA BASTEE	0.0030	8	28.67	8	0.61	51	1.17	43	1.76	32.21	
92 46	NETAJI NAGAR COLONY	0.0060	9	31.54	9	0.67	56	1.29	47	1.93	35.43	
93 46	NORTH MALLA GURI	0.0010	3	11.99	3	0.26	21	0.49	18	0.73	13.47	
94 46	PROMOD NAGAR	0.0020	7	26.85	7	0.57	48	1.10	40	1.64	30.16	
95 46	PUKALIOTE	0.0030	18	64.90	18	1.38	115	2.65	97	3.98	72.91	
96 46	RAJIV NAGAR	0.0090	3	9.12	3	0.19	16	0.37	14	0.56	10.25	
97 46	S.NARMADA BAGAN	0.0010	12	44.57	12	0.95	79	1.82	67	2.73	50.07	
98 46	SAMAR NAGAR COLONY	0.0140	9	30.76	9	0.66	55	1.26	46	1.88	34.55	
99 46	SATYAJIT NAGAR COLONY	0.0030	8	28.41	8	0.61	51	1.16	42	1.74	31.92	
100 46	SHIB NAGAR COLONY	0.0040	12	42.49	12	0.91	76	1.74	64	2.60	47.73	
101 46	UJANU SHIB NAGAR	0.0010	13	45.35	13	0.97	81	1.85	68	2.78	50.95	
102 46	UTPAL NAGAR	0.0010	4	13.29	4	0.28	24	0.54	20	0.81	14.93	
103 47	MAHAMAYA COLONY	0.0100	15	52.65	15	1.12	94	2.15	79	3.23	59.15	
104 47	PATI COLONY	0.1510	5	17.20	5	0.37	31	0.70	26	1.05	19.33	
105 47	PROMOD NAGAR COLONY	0.0140	5	16.42	5	0.35	29	0.67	25	1.01	18.45	
106 47	RAMKRISHNA COLONY	0.0010	8	29.45	8	0.63	52	1.20	44	1.80	33.09	
107 47	RAMKRISHNA NAGAR-A	0.0010	18	65.16	18	1.39	116	2.66	97	3.98	73.21	
108 47	RAMKRISHNA NAGAR-B	0.0440	7	26.85	7	0.57	48	1.10	40	1.84	30.16	
TOTAL			1645	5926	1645	126	10536	242	8861	363	6658	

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Executive Engineer
Siliguri Municipal Corporation
Siliguri

Commissioner
Siliguri Municipal Corporation

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Executive Summary

Project Details

Name of the State:	:	West Bengal
Name of the District:	:	Darjeeling
Name of the City:	:	Siliguri MC
Project Name:	:	HFA - SILIGURI MC 2018-19
Project Cost (Rs. in Lakhs)	:	11,051.04
Central Share (Rs. in Lakhs)	:	4,095.00
State Share (Rs. in Lakhs)	:	5,498.22
ULB Share (Rs. in Lakhs)	:	502.32
Beneficiary share (Rs. in Lakhs)	:	955.50
Total Infrastructure Cost (Rs. in Lakhs)	:	1,203.93
Percentage of Infrastructure Cost of Housing Cost	:	10
Infrastructure Cost per Dwelling Unit (Rs. in Lakhs)	:	0.368
Year of Implementation	:	2018-19
Component Housing Construction	:	Beneficiary Led Construction (BLC)
SOR Adopted	:	PWD (WB) w.e.f 1.7.14 with current corrigendum

Project Contributions (Physical + Financial) (Rs. in Lakh)

Sl	Scheme Component	Type	Qty	Unit	Rate (in Rs/Unit)	Proposed Project Cost (In Lakh)	Appraised Project Cost (In Lakh)	Central Share (Rs. 1.5Lakh/ DU)	State Govt. Share (Rs. 1.83Lakh/ DU)	ULB Share @ 0.184 Lakh/ DU	Beneficiary Share @ 0 Lakh/DU
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HOUSING

1	New in-situ										
	Single Storied Units		2730	Nos	368000.00	12,039.30	12,039.30	4,095.00	4,995.90	0.00	955.50
Total Housing Cost Sub Total (A)											955.50

B. INFRASTRUCTURE

Sl	Scheme Component	Type	Qty	Unit	Rate (in Rs/Unit)	Proposed Project Cost (In Lakh)	Appraised Project Cost (In Lakh)	Central Share (Rs. in Lakh)	State Govt. Share (@50%) (in Lakh)	ULB Share (@50%) (in Lakh)	Beneficiaries Share (in Lakh)
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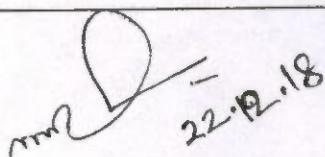
1 ROADS

		CEMENT CONCRETE ROAD	24499	SQ.M	1638.8	401.30	401.30	0.00	167.43	167.43	0.00

Executive Engineer
Siliguri Municipal Corporation

Commissioner
Siliguri Municipal Corporation

WATER SUPPLY										
		62585	RM	400	250.34	250.34	0.00	104.45	104.45	0.00
STORM WATER DRAINS										
	CEMENT CONCRETE Drains	24044	RM	2297	552.29	552.29	0.00	230.44	230.44	0.00
Total Infrastructure Cost Sub Total (B)				1,203.93	1,203.93	0.00	502.32	502.32	0.00	
GRAND TOTAL (A+B)				11,051.04	11,051.04	4,095.00	5,498.22	502.32	955.50	



22.12.18

Signature of the ULB level Executive Engineer
Competent Technical Officer Siliguri Municipal Corporation

Name & Designation:

Signature of the State level Competent Technical Officer

Name & Designation: Chief Engineer, MeDte, GoWB
Bikash Bhavan, South Block, 1st Floor, Salt lake, Kol-91


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Fax No:


Telephone No: 033-23371331

E-mail:

E-mail: ce_medte@yahoo.com

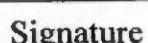

Director(SUDA)

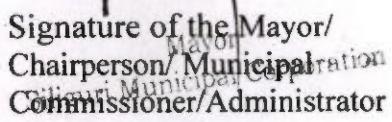

Signature of the Mayor/
Chairperson/ Municipal Corporation
Commissioner/Administrator

Name & Designation:

Smt D. Dutta Gupta,
Director, SUDA

Name & Designation:

Fax No:

033-23585767

Fax No:

Telephone No:

033-23585767

Telephone No:

E-mail:


wbsudadir@gmail.com

E-mail:

SILIGURI MUNICIPAL CORPORATION						
PMAY (HFA-2022)						
SL. NO	DESCRIPTION OF WORK	QUANTITY(Slum)	QUANTITY(Non Slum)	UNIT	RATE PER UNIT (In Rs.)	TOTAL COST (Rs. In lakh)
1	DRAIN	2273	10536	Metre	2297.00	294.22
2	CEMENT CONCRETE ROAD (2.5 metre wide)	1960	8861	Metre	4097	443.34
Total =						737.56

P. Basu *[Signature]*
Executive Engineer
Siliguri Municipal Corporation
Siliguri

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Commissioner
Siliguri Municipal Corporation
Act.

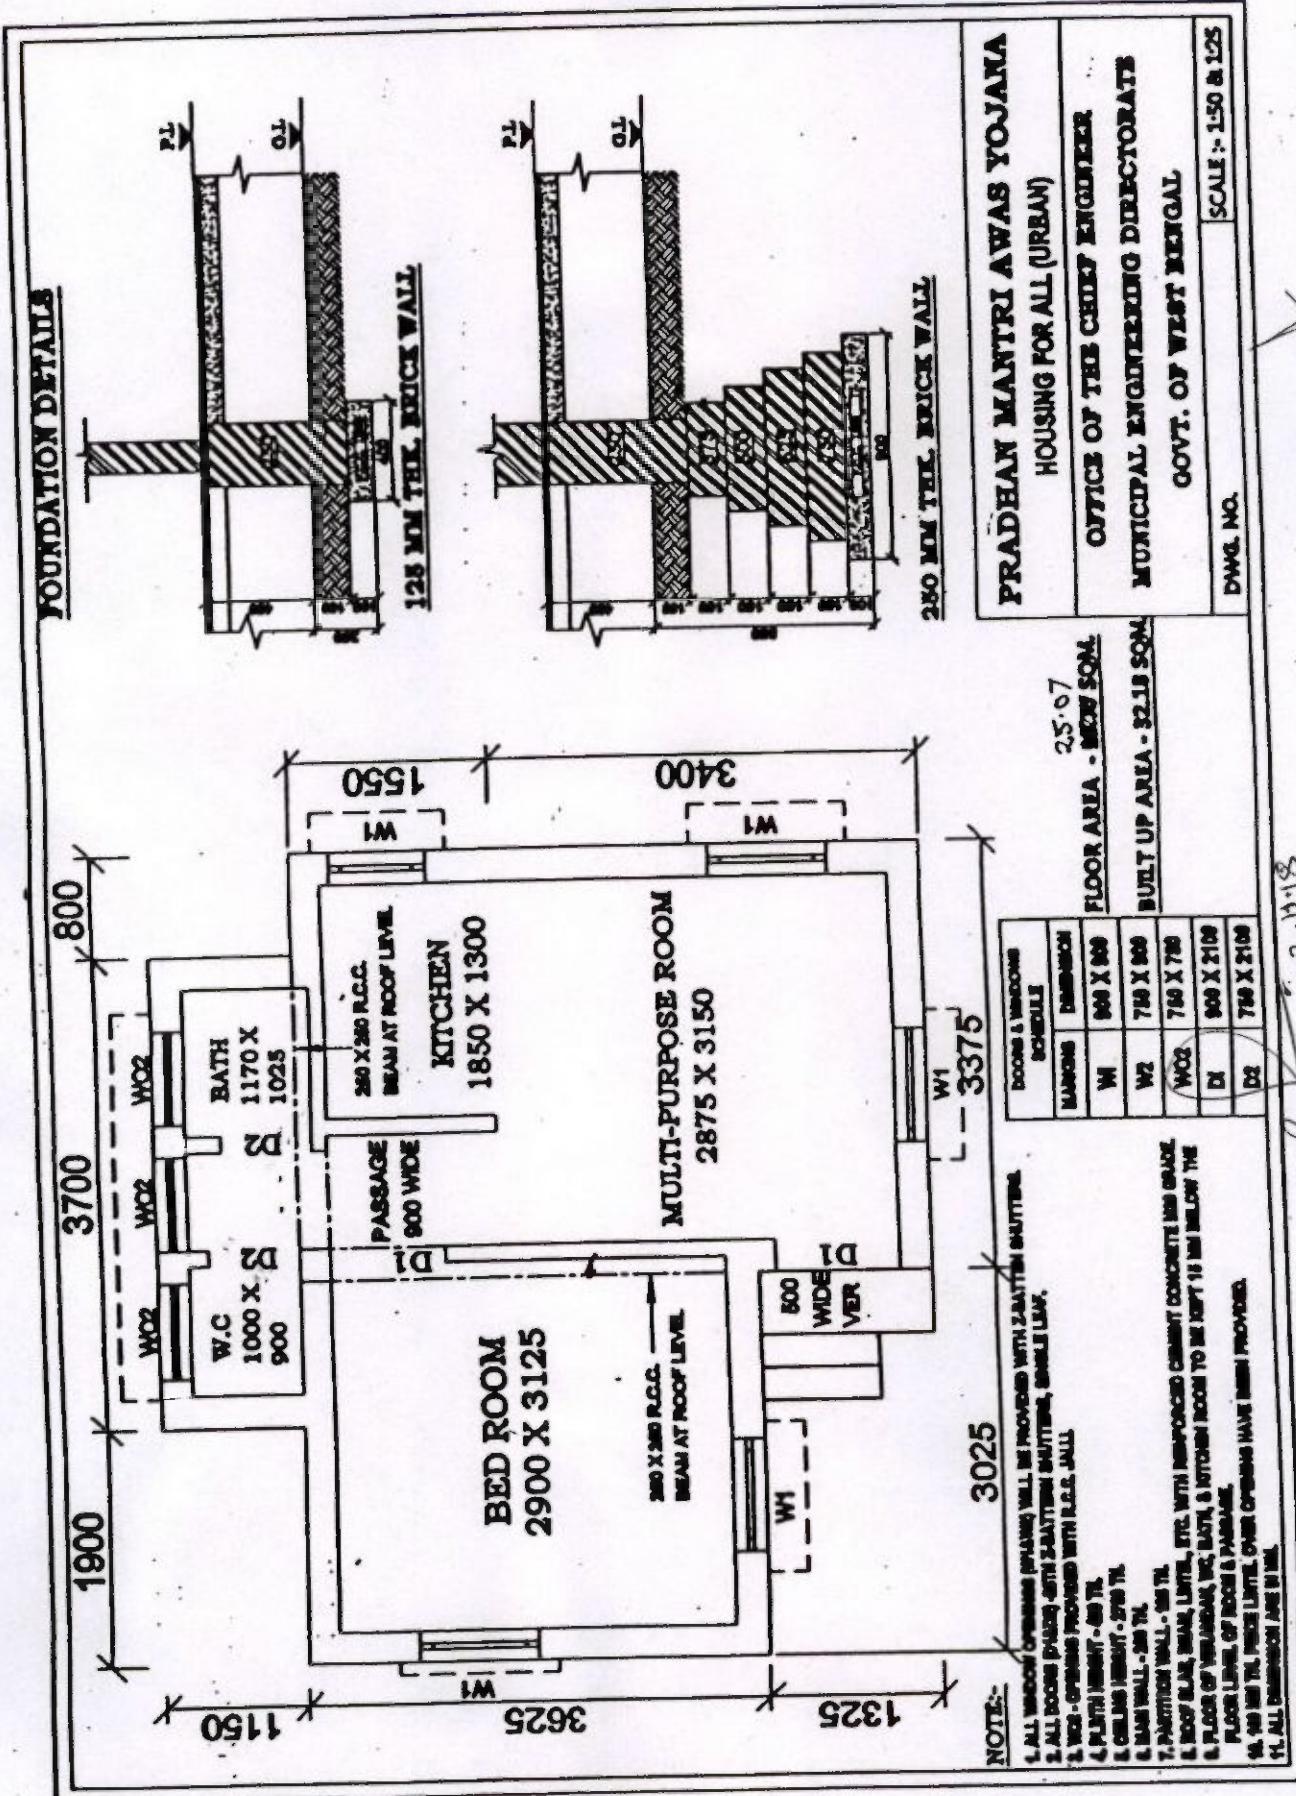

Executive Engineer,
Siliguri Municipal Corporation
Siliguri

Commissioner,
Siliguri Municipal Corporation
Clerk

ANNEXURE- I DETAILED ESTIMATE FOR THE CONSTRUCTION OF SINGLE UNIT DWELLING HOUSE

Pradhan Mantri Awas Yojana Housing For All (Urban)

Total Covered Area- 32.18 sq.m (With Electrical Works)

Reference of Schedule of Rates : PWD (W.B.), Schedule of Rates Building & Sanitary w.e.f-01.07.2014 & Corrigenda

Kolkata /24 Pgs (N & S)/ Kalyani Sub Div.)

Floor Area 25.37 sqm

SL No.	Description of Works	Quantity	Unit	Rate (Rs.)	Amount (Rs.)
1	Earthwork in excavation in foundation trenches or drains, in all sorts of soil (including mixed soil but excluding laterite or sandstone) including removing spreading or stacking the spoils within a lead of 75 m as directed including trimming the sides of trenches, levelling, dressing and ramming the bottom, bailing out water etc. as required complete. a) Depth of excavation not exceeding 1500mm . SOR, PWD, P-1, I -2 a	13.000	%cu.m	12047.00	1566.11
2	Earth work in filling in foundation trenches or plinth with good earth in layers not exceeding 150 mm. including watering and ramming etc. layer by layer complete.(Payment to be made on the basis of measurement of finished quantity of work) a) With earth obtained from excavation of foundation. SOR, PWD, P-1, T/3 a	11.120	%cu.m	7831.00	870.81
3	Supplying Laying Polithin Sheets etc. SOR, PWD, P-45, T - 13	22.000	sqm	25.00	550.00
4	Cement concrete with graded Stone ballast (40 mm.) excluding shuttering.a) In ground floor and foundation.6 : 3 : 1 proportion Pakur variety SOR, PWD, Page 24 ; Item -10 a	3.500	cu.m.	5823.00	20380.50
5	25 mm. thick damp proof with cement concrete (4:2:1) (with graded stone aggregate 10 mm. Normal size) and painting the top surface with a coat of bitumen using 1.7 kg. per sq.m. including heating the bitumen and cost and carriage of all materials complete. SOR, PWD, P-45, T-12	6.810	sqm,	297.00	2022.57
6	Brick work with 1st class bricks in cement mortar (6:1) a) In foundation and plinth. b) In super structure SOR, PWD, P-29, T -22(a), (b)	10.430	cum	5719.00	59649.17
7	125mm thick brick work with 1st. class bricks in cement mortar (4:1). a) In ground floor SOR, PWD, P-73, I -29	15.240	cum	5943.00	90571.32
8	Ordinary Cement concrete (mix 1:1.5:3) with graded stone chips (20 mm nominal size) excluding shuttering and reinforcement if any, in ground floor as per relevant IS codes. (i) Pakur Variety SOR, PWD, P-14, T -7(i)	23.220	sq.m.	783.00	18181.26
9	Reinforcements for reinforced concrete work in all sorts of structures including distribution bars, stirrups, binders etc. including supply of rods, initial straightening and removal of loose rust (if necessary), cutting to requisite length, hooking and bending to correct shape, placing in proper position and binding with 16G black annealed wire at every intersection..complete as per drawing and direction. (a) For works in foundation, basement and upto roof of ground floor / upto 4m. (i) Tor steel/Mild steel. SOR, PWD, P-27, T -15(i)	3.940	cu.m.	6851.66	26995.54
		0.309	MT	60705.93	18775.74

P.Bose
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Executive Engineer
Siliguri Municipal Corporation
Siliguri
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Commissioner
Siliguri Municipal Corporation

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Sl. No.	Description of Works	Quantity	Unit	Rate (Rs.)	Amount (Rs.)
10	Hire and labour charges for shuttering with centreing and necessary staging upto 4 m. using approved stout props and thick hard wood planks of approved thickness with required bracing for concrete slabs, beams, columns, lintels curved or straight including fitting, fixing and striking out after completion of works. (upto roof of ground floor). (When the height of a particular floor is more than 4 m. the equivalent floor ht. shall be taken as 4 m. and extra for works beyond the initial 4 m. ht. shall be allowed under 12(e) for every 4 m. or part thereof.) SOR, PWD, P-66, T-12(a) 25 mm. to 30 mm. thick wooden shuttering as per decision & direction of Engineer-in-charge. Ground Floor	37.063	M ²	360.00	13342.68
11	Plaster (to wall, floor, ceiling etc.) with sand and cement mortar including rounding off or chamfering corners as directed and raking out joints or roughening of concrete surface, including throating, nosing and drip course where necessary . In ground floor. A) With 6:1 cement mortar. a) Inside wall 20 mm thick plaster SOR, PWD, P-151, T - 2 (I)(b)	116.940	sq.m.	181.00	21166.14
	b) Out side Wall, 15mm th. SOR, PWD, P-151, I - 2 (I)(c)	111.950	sq.m.	156.00	17464.20
	B)10mm th ceiling plaster (4:1) SOR, PWD, P-151, I - 2 (I)(c)	23.330	sq.m.	140.00	3266.20
12	Neat cement punning about 1.5mm thick in wall, dado, window, sills, floor, drain etc. SOR, PWD, P-152, I - 8	26.700	sq.m.	38.00	1014.60
13	Artificial stone In floor,dado, staircase etc. with cement concrete (4:2:1) with stone chips laid in panels as directed with topping made with ordinary or white cement (as necessary) and marble dust in proportion (2:1) including smooth finishing and rounding off corners and including application of cement slurry before flooring works, using cement @ 1.75 kg./sq.m. all complete including all materials and labour. In ground floor. 3 mm. thick topping (High polishing grinding on this item is not permitted) with ordinary cement. 20mm thick SOR, PWD, P-40, I - 3 (i)	26.490	sq.m.	265.00	7019.85
14	Supplying, fitting & fixing MS clamp for fixing door and window frame made of flat bent bar, end bifurcated, fixed in cement concrete with stone chips (4:2:1)a fitted and fixed complete as per direction. 40mm x 6mm 125 mm length. (Cost of cement concrete will be paid separately) SOR, PWD, P-90, I - 18 (c)	34	each	22.00	748.00
15	Wood work in door and window frame fitted and fixed complete including a protective coat of painting at the contact surface of the frame other Local wood SOR, PWD, P-85, T -1(i)	0.213	cu.m.	46171.00	9834.42
16	Panel Shutter of door & Window (each Panel Consisting Of single Plan without Join) 25 mm thick shutter with 12 mm thick Panal of size 30 to 45 cm. Other Local wood SOR, PWD, P-105, I - 84 (iv)	8.520	sq.m.	1567.00	13350.84
17	Iron butt hinges of approved quality fitted and fixed with steel screws, with ISI mark. a)75mm x 47mm x 1.70mm SOR, PWD, P-91, T -20(iv)	32.000	each	34.00	1088.00
18	Iron Socket Bolt of approved quality fitted and fixed complete. i) 150 mm long x 10 mm dia SOR, PWD P-93, I-25,c	11.000	each	71.00	781.00
19	White washing including cleaning and smoothening surface thoroughly (5 parts of stone lime and 1 part of shell lime should be used in the finishing coat). Two Coats SOR, PWD, P-155, I - 3 (b)	124.960	%sq.m	1887.00	2358.00
20	Colour washing with emulsion with a coat of white wash priming including cleaning and smoothing surface thoroughly external surface One Coat SOR, PWD, P-155, I - 4(ii)(a)	100.560	%sq.m	1514.00	1522.48
21	Priming one coat on timber, plastered or on steel or other metal surface with synthetic enamel/oil bound primer of approved quality including smoothening surfaces by sand papering etc. 1) On timber surface SOR, PWD, P - 162, I - 7(a) 2) On Steel Surface SOR, PWD, P - 162, I - 7(b)	21.690	sq.m.	41.00	889.29
		2.700	sq.m.	31.00	83.70
22	Painting with best quality synthetic enamel paint of approved make and brand Including smoothening surface by sand papering etc. Including using of approved putty etc. on the surface, if necessary : With suner gloss (hi-gloss)-With any shade except white. a) On timber or plastered surface Two Coats SOR, PWD, P - 162, - 8A(all),(bil)	21.690	sq.m.	89.00	1930.41
	b) On Steel surface Two Coats SOR, PWD, P - 162, - 8A(all),(bil)	2.700	sq.m.	86.00	232.20
23	Iron hasp bolt of approved quality fitted and fixed complete (oxidised) with 16 mm dia with center bolt and round fitting. 300 mm long SOR, PWD, P-93, I - 27c	2.000	each	193.00	386.00

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S.A.E (HFA)
Assistant Engineer
Corporation

SL No.	Description of Works	Quantity	Unit	Rate (Rs.)	Amount (Rs.)
24	Precast piered concrete jally work as per design and manufacturer's specification including moulding etc. with stone chips and necessary reinforcement shuttering complete including fitting, fixing in position in all floors. (a) 37.5 mm th. panels Cement & steel required for this item will not be issued by deptt. SOR, PWD, P-32, I - 38 (b)	1.690	sq.m.	351.00	593.19
25	Supplying, fitting and fixing UPVC down pipes A type and fittings conforming to IS 13592-1992 with necessary clamps nails including making holes in walls, etc. and cutting trenches in any soil, through masonry concrete structure etc. If necessary and mending good damages including jointing with jointing materials (Spun yarn, valamoid / bitumen / M. seal etc.) complete. P-173, I-21 A (ii), C(ii), D(ii) SOR, PWD, P173, I - 21 A (ii), C(ii), D(ii)				
	I) UPVC Pipe 110 mm dia	3.000	Mtr.	291.00	873.00
	II) UPVC Bend 87.5 degree 110 mm dia	2.000	each	162.00	324.00
	III) UPVC Shoe 110 mm	1.000	each	128.00	128.00
26	M.S.or W.I. Ornamental grill of approved design joints continuously welded with M.S. W.I. Flats and bars of windows, railing etc. fitted and fixed with necessary screws and lugs in ground floor. Grill weighing 10 kg/sqm to 16 kg/m ² SOR, PWD, P - 76, I - 10 (i) (2.70sqm @ 10.5kg per sqm = 28.35 kg)	0.284	Qntl	8247.00	2342.15
27	Shallow water closet Indian pattern(I.P.W.C.) of approved make in white vitreous chinaware supplied ,fitted and fixed in position (excluding cost of concrete for fixing). 450 mm long SOR, PWD, (Sanitary) P - 65, I - 1 (iii)	1.000	each	1062.00	1062.00
28	Foot rest for water closet of size 275 mm X 125 mm with Artificial stone(4:2:1) with 6 mm stone chips and chequered including adding colour as necessary. SOR, PWD, (Sanitary) P - 66, I - 9	1.000	Pair	70.00	70.00
29	Supplying,fitting and fixing cast iron 'P' or 'S' trap conforming to I.S. 3989 / 1970 and 1729 / 1964 including lead caulked joints and painting two coats to the exposed surface. S Trap 100 mm SOR, PWD, (Sanitary) P - 54, I - 14(B-iii)	1.000	each	923.00	923.00
30	Supplying, fitting fixing CI Round Gratings 150mm dia SOR, PWD, (Sanitary) P - 55, I - 18(ii)	1.000	Each	100.00	100.00
	Construction of 2 circular leach pit of inside diameter 1000 mm. & a depth of 1000 mm. With a layer of 250 mm. Thick brick work with cement mortar (6:1) & honeycombed brick wall (4:1) at every alternate layer upto a height of 925 mm. From bottom and then 125 mm. thick brick wall (4:1) for a height of 300 mm. and covered with 75mm. RCC slab (4:2:1) with 8mm tor steel @ 150 mm. centre to centre both ways including plastering and neat cement punning on top of the slab and making hooking arrangement on slab for lifting of the slab if require as well as jointing the connection with the inspection pit (450 x 450) covered with 50mm thick RCC slab (4:2:1) with stone chips and necessary renforcement and connected with 100 mm dia PVC pipe laid over rammed earth and then covered the pipe properly with powder earth including supplying fitting fixing fibre glass pan P-tap & polythene pipe as per requirement to connect with the inspection pit complete with all respect as per direction of EIC.(ANNEXURE-II)	1	Item	7544.00	7686.00
TOTAL AMOUNT			Rs.	350142.36	360314.00
Say			Rs.	350142.00	
Add for Electrical Works (ANNEXURE-I)			Rs.	17858.00	
TOTAL AMOUNT			Rs.	368000.00	
(Rupees Three lakh Sixty seven thousand Eight hundred & Fifty eight only)					

*R.P.Bose
S.A.E. (HFA)*

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Executive Engineer
Siliguri Municipal Corporation
S.M.C.

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Commissioner
Siliguri Municipal Corporation
a/c.

**ANNEXURE-II ESTIMATE FOR ELECTRICAL WORKS FOR ONE DWELLING UNIT UNDER
RAY**
(ANNEXURE-I)

SLN No.	Item of works	Unit	Rate	Quantity	Amount
1	Supplying & fitting polythene pipe complete with fittings as necessary. Under ceiling /beam/bound with 22SWG GI wire inclusive S & Drawing 1x18 SWG GI wire as fish wire inside the pipe & fittings and providing 55 mm dia disc of MS sheet (20SWG) having colour paint at one face first ended at the load point end of the polythene pipe with fish wire (synchronizing with roof/beam casting work of building construction) 19 mm dia 3 mm thick polythene pipe	RM	39.00	25.00	975.00
2	Powerckt wiring supplying and drawing 1 ; 1KV grade single core stranded FR PVC insulated & unseathed single core stranded Copper wire (Finolex make) 2 x 2.5 sqmm (PH & N) +1x1.5 sqmm (ECC) per laid polythene pipe and by the prelaid GI fish wire & making necessary connections as required.	RM	76.00	50.00	3800.00
3	Concealed Distribution wiring in 2x1.5 sqmm single core standard *FR* insulated and unseathed copper wire Finolex make & 1x1.5 sq mm single core stranded PVC cinsulated and unseathed cop per (Finolex make) wire used as ECC in 19 mm bore 3 mm thk. polythene pipe complete with all accessories embedded in wall smooth run to light / fan/call bell point with pino key type switchb (6 Amps) (Anchor make) fixed on sheet metal (16 SWG) Switch Board with bakelite/ perspex (wall maching colour) Top cover (3 mm thick) flushed in wall including mending all good damages to original finish Average per point 6.00 mt.	points	828.00	10.00	8280.00

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Sl. No	Item of works	Unit	Rate	Quantity	Amount
4	Deistribution concealed wiring with 2x1.5 sq mm (PH & N) single core stranded FR PVC insulated & unsheathed single core strranded 1.1 KV grade Copper Wire (finolex) & 1x1.5 sq mm (ECC) single core stranded (PH & N) 1.1 KV grade cu wire (finolex) & 1 x 1.5 sq mm single core stranded PVC insulted & unsheathed cu wire (finolex) used as ECC in 19 mm bore, 3 mm thick polythene pipe complete with all accessories embedded in wall 250 volt 5 amp 3 pin plug point including S & F 250 Volt 5.amp 3 pin flush type plug socket & piano key type swich (Anchor make) on existing switch board as mentioned sl. no.3	points	76.00	2.00	152.00
5	Supplying & drawing 1.1 KV grade single core strnded FR PVC insulated & unseathed single core strnded cu Wire 3x2.5 sq mm (finolex make) in the prelaid polythene pipe & by the prelaid GI fishwire & making necessary connection as required (CESC supply to consumer DP near to CESC & inside the room another DP near CESC & inside the room another DP of dwelling units)	RM	86.00	15.00	1290.00



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Sl.No.	Item of works	Unit	Rate	Quantity	Amount
		Unit	Rate	Quantity	Amount
6	Supplying Delivery & instalation on wall of 30/32 amp DP MCBof Havel's make with enclosed box along with all its necessary 1 connection complete.(Anchor)	nos	808.00	2	1616.00
7	Earthing in soft soil with 50 mm dia GI pipe (TATA make Medium) 3.64 mm th. X 3.04 Mtr long and 1 x 4 SWG GI (hot dip) wire (4 m long) 13 mm dia x 80 mm long GI bolts, double nuts, double washer including S & F 15 mm dia GI protection (1 mtr long) to be filled with bitumen partlyunder the ground level & partly above GL driven to an average depth of 3.65 m below the GL & restoring surface duly rammed.	each	1715.00	1	1715.00
8	Connecting the equipment to earth BUSbar inclusive S&F 10 SWG (Hot Dip) GI wire on wall /floor with a staples buried inside wall /floor as required & making connection to equipments with bolt, nut, washer, cable lugs etc. as required & mending good damages.	M	6.00	5	30.00
		TOTAL		17858.00	
Rupees Thirteen Thousand Eight Hundred Seventy Eight Only				17858.00	


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ANNEXURE-III Detailed Estimate for Single Dwelling unit

Floor area 25.36 sqm Built up area 32.18 sqm

C/L of main outer wall	125 mm Partitionwall			Varandah	C/L
4.65		3.375		1.275	
0.8		1.15		0.9	
1.15		1.15	2.3	2.175	
3.45		2.187			
1.15		1.9			
1.7		1.387	5.474		
3.375		11.149			
1.275					
2.825					
3.125					
23.5					
X wall	1.25				
Sl.no.					
1	Earth work in excavation				
	250 mm wall				
	1 23.5	0.75	0.7	12.34	
		0.875	0.75	0.46	
		24.375		12.8	m ³
	125 mm Wall				
	2.625		0.4 0.225	0.24	
	WC	0.4 0.4		0.04	
	Bath	0.65 0.4		0.06	
	5.474	0.75		0.225	
		4.724	0.4	0.225	0.43
	Varanda	1.425	0.4	0.225	0.13
					0.88
	Step	0.5 0.9	0.075	0.034	
				13.715	m ³
2	Soling				
	24.375	0.75		18.281	
	11.45	0.4		4.58	
				22.861	
3	Polythene sheet				
		2.575	3.125	8.047	
		2.875	2.625	7.547	
		2	1.65	3.3	
	passage	0.625	2.375	1.484	
	Bath&WC	2.7	0.9	2.43	
	Varndah	1.025	0.6	0.615	
	step	0.9	0.5	0.45	
				23.873	
4	Jhama concrete				
		18.28	0.075	1.371	
		4.58	0.075	0.344	
		23.93	0.075	1.795	
				3.51	
5	Earth work in filling 1/5 excavation				
		13.715	5	2.743	
		23.48	0.375	8.805	
				11.548	m ³

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6	B.W (6:1) in Foundation of plinth			
	23.5	0.625	14.6875	
	23.5	0.5	11.75	
	23.5	0.375	8.8125	
			35.25	0.15 5.288
	23.5	0.25		0.525 3.084
X wall	0.938	0.625	0.586	
	1	0.5	0.5	
	1.063	0.375	0.399	
			1.485	0.15 0.223
	1.125	0.25		0.525 0.148
125mm	3.125	0.25		0.525 0.41
Bath&WC		2.09	0.25	0.523 0.235
Kit	5.224	0.25		0.525 0.686
Vard	1.925	0.25		0.525 0.253
Steps		0.5 0.9		0.15 0.068
		0.25 0.9		0.15 0.034
				10.427 m ³
7	DPC	23.5		
	1.125			
	24.625		0.25	6.156
	3.125			
	1.8			
	5.224			
	10.149		0.125	1.269
				7.425
Less		0.9	0.25	0.225
		0.9	0.125	0.113
3	0.75		0.125	0.281
				0.619
				6.806 sqm
8	BW in super structure (6:1)			
	23.5			
	1.125			
	24.625	2.75	0.25	16.93
Parapet	23.8	0.075	0.25	0.446
				17.376
Less opens				
1	0.9	2.1	1.89	
4	0.9	0.9	3.24	
1	0.75	0.9	0.675	
3	0.75	0.75	1.688	
			7.493	0.25 1.873
Lintel				
1	1.525	1.525		
4	1.2	4.8		
1	1.05	1.05		
		7.375	0.25	0.1 0.184
Wo2				
1	3.05	3.05	0.25	0.1 0.076
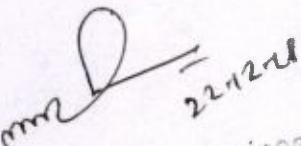
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			(-)	2.134	
	Net brick work			15.242	m ³
9	125 th. Brick work (6:1)				
room		3.125	2.6	8.125	
kit		2.125	2.75	5.844	
		1.65	2.75	4.5375	
		1.45	2.65	3.8425	
2		0.9	2.1	3.78	
				26.12875	
	Less opening				
1	0.9	0.9			
3	0.75	2.25			
.		3.15	2.1	6.615	
Lintel					
1	1.3	1.3			
1	1.025	1.025			
		2.325	0.1	0.2325	
				6.8475	
				19.28125	
	Parapet				
	23.5		0.15	3.525	
				22.806	
passage	0.75	0.55		0.4125	
				23.219	sqm
10	Conc M-20				
Roof slab					
32.15	1.1475	31.003		0.1	3.1
Beam		3.625	0.25	0.15	0.136
		2.575	0.25		0.1 0.064
Lintel					3.301
D1		1.1.525	1.525		
W1		4.1.2	4.8		
W2		1.1.05	1.05		
W02		1.3.05	3.05		
			10.425	0.25	0.1
D1		1.1.39	1.39		
D2		1.1.025	1.025		
D2		2.1.4	2.8		
O2		1.0.875	0.875		
D2		2.6.09	0.125	0.1	0.076
Chaja					
W1		4.1.2	4.8		
W2		1.1.03	1.03		
D1		1.1.275	1.275		
W02		1.3.05	3.05		
			10.155	0.3	0.075
					0.228
					3.866 m ³
11	Reinforcement				
		3.866	0.80% 1	7850	0.243 MT

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12	Shuttering					
31	23.5	1.125				
		24.63	0.25			
31			6.156	24.844		
Side beam		2 3.125	0.15	0.9375		
		2 2.325	0.1	0.465		
side slab		1 25.3	0.1	2.53		
Lintel		1 0.9	0.25	0.225		
		1 1.525	0.1	0.153		
		1 1.275	0.35	0.446		
		1 0.3	0.05	0.015		
				29.615	sqm	
4W1		4 0.9	0.25	0.9		
		4 1.2		0.1 0.48		
		4 1.2	0.35	1.68		
2		4 0.3	0.05	0.12		
1W2		1 0.75	0.25	0.188		
		1 1.05		0.1 0.105		
		1 1.05	0.35	0.368		
2		1 0.3	0.05	0.03		
WO2		3 0.75	0.25	0.563		
1		1 3.05		0.1 0.305		
		1 3.05	0.35	1.068		
2		1 0.3	0.05	0.03		
Lintel 125 Wall						
D1		1 0.9	0.125	0.113		
		2 1.3	0.1	0.26		
D2		2 0.75	0.125	0.188		
2		2 1.15	0.1	0.46		
D2		2 0.75	0.125	0.188		
		2 1.9	0.1	0.38		
				7.423		
				37.038	sqm	
13	Plaster (6:1)					
Out side 15 mm th.						
		2.85	3.125	0.45		
		25.3		4.425	111.953	sqm
Inside 20 mm th.						
-	2 2.7	3.125	2.75	32.038		
	2 2.875	2.625	2.75	30.25		
	2 2	1.65	2.75	20.075		
	2 2.075		2.75	11.413		
Above lintel						
	1	0.75	0.65	0.488		
Bath						
	2	0.9	2.75	4.95		
WC						
	1	2.95	2.75	8.113		
	1	2.25	2.75	6.188		
	4	2.2	0.9	7.92		
T. 125 wall						

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	D1+D2				12		
W1		4	4		16		
W2		1	4		4		
						32 nos.	
20	Iron socket bolt			6			
Door				5			
Window						11 nos.	
21	White wash						
	Inside+Ceiling Plaster- inside punning						
		116.933	23.33	15.31	124.953	sqm	
22	Colour wash						
	Out side Plaster- out side punning						
		111.953	11.385		100.568	sqm	
23	Priming on timber surface						
	2	2 0.9	2.1		7.56		
	2	2 0.75	2.1		6.3		
	4	2 0.9	0.9		6.48		
	1	2 0.75	0.9		1.35		
					21.69	sqm	
24	Painting best quality on wooden surface						
	same sl.no. 23				21.69	sqm	
25	MS ornamental grill....10Kg-16 Kg						
W1		4 0.75	0.75	2.25			
W2		1 0.75		0.6 0.45			
				2.7			
				@12Kg/sqm	32.4	Kg	
26	Priming on Steel surface				2.7	sqm	
27	Painting best quality on steel surface				2.7	sqm	
	same sl.no. 24						
28	R.C.C. Shelf						
		1.75 0.5			0.875	sqm	
29	Roof treatment with cow dung						
			32.18				
Deduct		1.14 (varanda)	1.14				
Cornice		25.0.125	3.125				
			27.915		27.915	sqm	

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	D1+D2				12	
	W1	4	4		16	
	W2	1	4		4	
						32 nos.
20	Iron soket bolt					
	Door			6		
	Window			5		
						11 nos.
21	White wash					
	Inside+Ceiling Plaster- inside punning					
		116.933	23.33	15.31	124.953	sqm
22	Colour wash					
	Out side Plaster- out side punning					
		111.953	11.385		100.568	sqm
23	Priming on timber surface					
	2	2 0.9	2.1		7.56	
	2	2 0.75	2.1		6.3	
	4	2 0.9	0.9		6.48	
	1	2 0.75	0.9		1.35	
					21.69	sqm
24	Painting best quality on wooden surface					
	same sl.no. 23				21.69	sqm
25	MS ornamental gril...10Kg-16 Kg					
	W1	4 0.75	0.75	2.25		
	W2	1 0.75		0.6 0.45		
				2.7		
				@12Kg/sqm	32.4	Kg
26	Priming on Steel surface				2.7	sqm
27	Painting best quality on steel surface				2.7	sqm
	same sl.no. 24					
28	R.C.C. Shelf					
		1.75 0.5			0.875	sqm
29	Roof treatment with cow dang					
			32.18			
	Deduct	1.14 (varanda)	1.14			
	Cornice	25 0.125	3.125			
			27.915		27.915	sqm

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ANNEXURE-IV Cost Estimate for 2 Nos Leach Pit for single unit Dwelling Unit
P.W.D Schedule of Rates effect from 1st July 2014

(ANNEXURE-II)

Sl No	Description of Items	Quantity	Unit	Rate	Amount
1	Earth work in excavation of foundation trenches or drains in all sorts of soil (including mixed soil but excluding or stacking the spoils within a lead of 75 m. as directed. The item includes necessary trimming the sides of trenches leveling dressing and ramming the bottom boiling out water aqs required complete . Depth of excavation not existing 1500mm P.No-1, I-2(a)	2.552	%Cu.M	12047.00	307.44
2	Cement concrete with graded jhama Khoa ballast (30 mm size) excluding shuttering. In ground floor and foundation (a) 6:3:1 proportion.	0.050	Cu.M	5803.06	290.15
3	Brick work with 1st class bricks in cement mortar (6 :1). a) In foundation & Plinth P.no-29, I-21(a)	0.011	Cu.M	5719.00	62.91
4	125 mm. thick brick work with 1st class bricks in cement mortar (4 : 1) G.Floor	3.000	SqM	714.00	2,142.00
5	Controlled Cement concrete with well graded stone chips (20 - mm nominal size) excluding shuttering and reinforcement with complete design of concrete as per 1 : 456 and relevant special publications submission of job mix formula after preliminary mix design after testing of concrete cubes as per direction of Engineer-in charge Consumption of cement will not be less than 300 Kg of cement -with Super plasticiser per cubic meter of controlled concrete but actual consumption will be determined on- the basis of preliminary test and job mix formula. -In ground floor and foundation. [Using concrete mixture] M 20 Grade P.no-12, I-6(a)	0.154	Cu.M	6871.54	1,058.22
6	Reinforcement for reinforced concrete work in all sorts of structures incl. Distribution bars, stirrups, binder etc. incl. supply of rods, initial straightening & removal of loose rust (if necessary), cutting to requisite length, hooking etc P.no-27, I-15(a)(i)	0.011	M.T	68508.00	753.59
7	Supplying, fitting and fixing UPVC down pipes A type and fittings conforming to IS 13592-1992 with necessary clamps nails including making holes in walls, etc. and cutting trenches in any soil, through masonry concrete structure etc. if necessary and mending good damages including jointing with jointing materials (Spun yarn, valamoid / bitumen / M. seal etc.) complete.				
	i) UPVC Pipe 110 mm dia P.no-173, I-21(A)(i)	4.000	Mtr	291.00	1,164.00
	ii) UPVC Bend 87.5 degree 110 mm dia P.no-174, I-21(B)C(ii)	2.000	Each	162.00	324.00
8	Jaffri brick work 125 mm. thick with 1st class bricks in cement mortar (4:1) including 12 mm. thick cement plaster (4:1) in all faces in ground floor .P.no-32, I-35	2.000	SqM	792.00	1,584.00
Cost of 2 no leach pit				7,686.31	
Total=				7,686.00	

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ANNEXURE- V Rate Analysis
Brick Work 4:1 in foundation & plinth

Step - 1	Schedule Rate	Rs	6068.00(A)
Step - 2	Deduct cost of cement=(Quany of cement)x(lissue rate of cement vide item no-1 column-4 Table1-1 of Annexure-1 0.055x8100	Rs	672.30(B)
Step - 3	Add cost of cement supplied by cost contractor including 10% proffite = 1.1x(Quany of cement)x(Basik price of cement vide item no -1 column- 5 table-1-1 of annexure -1 1.1x.055x7364	Rs	672.33 (C.)
	Note:- Quantity of cement shall be same as step-2 Final Rate of item = Rs A - Rs B + Rs C = Rs D	Rs	6068.03 (D)

Rate Analysis
Ordinary Mix Concrete 1:1.5:3

Step - 1	Schedule Rate	Rs	6802.63 (A)
Step - 2	Deduct cost of cement=(Quany of cement)x(lissue rate of cement vide item no-1 column-4 Table 1-1 of Annexure-1 0.286x8100	Rs	2316.6 (B)
Step - 3	Add cost of cement supplied by cost contractor including 10% proffite = 1.1x(Quany of cement)x(Basik price of cement vide item no -1 column- 5 table-1-1 of annexure -1 1.1x.286x7364	Rs	2316.71 (C.)
	Note:- Quantity of cement shall be same as step-2 Final Rate of item = Rs A - Rs B + Rs C = Rs D	Rs	6802.74 (D)

Rate Analysis
P.C.C 1:3:6 With Jhama Khoa

Step - 1	Schedule Rate	Rs	5803.00 (A)
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Step - 2	Deduct cost of cement=(Quenty of cement)x(Issue rate of cement vide item no-1 column-4 Table 1-1 of Annexure-1 0.16x8100	Rs	1296.00(B)
Step - 3	Add cost of cement supplied by cost contractor including 10% proffite = 1.1x(Quenty of cement)x(Basik price of cement vide item no -1 column- 5 table-1-1 of annexure -1 1.1x.16x7364	Rs	1296.06 (C.)
	Note:- Quantity of cement shall be same as step-2 Final Rate of item = Rs A - Rs B + Rs C = Rs D	Rs	5803.06 (D)

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Annexure - VI

Format - A

(Format for Rate Analysis of Cement Concrete Item)

Item 7. Ordinary Cement concrete (mix 1:1.5:3) with graded stone chips (20 mm nominal size) excluding shuttering

Consumption of Stone aggregate (Page B-59)

20 mm = 0.573 Cum

10 mm = 0.287 Cum

10 Km

Distance of site considered =

Steps	Quantity	Unit	Rate	Amount
Step - 1 Rate of item as per relevant section of this Schedule A =	1.00	CUM	5389.00	5389.00
Step - 2 Add cost of stone aggregate of different grading as per consumption required for one cum of concrete.				
(As per table:T-1)				
Station : kalyani				
20mm Nominal Size:	0.573	CUM	1463.00	838.30
10mm Nominal Size:	0.287	CUM	1296.00	371.95
Total B =				1210.25
Step - 3 Add cost of carriage of stone aggregate as per consumption required for one cum of concrete.				
(As per table:T-2)				
20mm Nominal Size:	0.573	CUM	178.50	102.28
10mm Nominal Size:	0.287	CUM	178.50	51.23
Total C =				153.51
Step - 4 Add cost for loading and unloading of stone aggregate				
(As per table:T-3)				
20mm Nominal Size:	0.573	CUM	58.00	33.23
10mm Nominal Size:	0.287	CUM	58.00	16.65
Total D =				49.88
Final Rate of Item = [Rs. A - Rs.B + Rs.C + Rs.D] = Rs.				6802.64

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ANNEXURE-VII ESTIMATE FOR CONSTRUCTION OF CONCRETE ROAD 2.5 MTR WIDE

PWD BUILDING SCHEDULE 2014

Sl No	Description of Items	Length	Breadth	Depth	Quantity	Unit	Rate	Amount
1	Earth work in excavation of foundation trenches or drains in all sorts of soil (including mixed soil but excluding or stacking the spoils within a lead of 75 m. as directed. The item includes necessary trimming the sides of trenches leveling dressing and ramming the bottom boiling out water aqs required complete . Depth of excavation not existing 1500mm P.No-1, I-2(a)	1.00	2.5	0.400	1.000	%Cu.M	12047.00	120.47
2	Filling foundation or plinth by silver sand in layer not exceeding 150 mm. as directed and consolidating same by through saturation with water ramming complete. Including the cost of supply of sand. (a) by fine sand P.No-2 , I-4(B)	1.00	2.5	0.200	0.500	%Cu.M	110422.00	552.11
3	Single brick flat soling of picked jhama bricks including ramming and dressing bed to proper level and filling joints with powdered earth or local sand P.no-11, I-1	1.00	2.5		2.500	Sq.M	377.00	942.50
4	Ordinary Cement concrete (mix 1:1.5:3) with graded stone chips (20 mm nominal size) excluding shuttering and reinforcement, if any, in ground floor as per relevant IS codes P.no-24, I-10(a)	1.00	2.5	0.125	0.313	Cu.M	6802.74	2,125.86
5	Brick edging 75 mm. wide with picked jhama bricks, laid true to line and level including cutting necessary trench in sopil or in hard metalled surface, laying the bricks and repacking the trench (on both sides of the edgeing) with spoils and ramming the same thoroughly, complete as per direction. (b) Brick-on-end edging (250 mm) depth. P.No-189 , I-3(b)	2.00			2.000	%Mtr	9392.00	187.84
6	Removal of rubbish, earth etc. from the working site and disposal of the same beyond the compound in conformity with the Municipal Corporation Rules for such disposal, loading into truck and cleaning the site in all respect as per direction of Engineer - in -Charge P.no-9, I-13	1.00	2.500	0.400	1.000	Cu.M	168.00	168.00
Total=							4,096.78	
Total=							4,097.00	
Rate per Sq.M=							1638.8	

G. Rose
S.A.E. (HFA)

Sub-Inspector in Charge
Siliguri Municipal Corporation

22.12.18
Executive Engineer
Siliguri Municipal Corporation
Siliguri

Commissioner
Siliguri Municipal Corporation
W.

ANNEXURE-VIII

ESTIMATE FOR CONSTRUCTION OF SUR FACE DRAIN (300X300)

PWD BUILDING SCHEDULE 2014

Sl No	Description of Items	Length	Breadth	Depth	Quantity	Unit	Rate	Amount
1	Earth work in excavation of foundation trenches or drains in all sorts of soil (including mixed soil but excluding or stacking the spoils within a lead of 75 m. as directed. The item includes necessary trimming the sides of trenches leveling dressing and ramming the bottom boiling out water aqs required complete . Depth of excavation not existing 1500mm P.No-1, I-2(a)	1.00	0.95	0.475	0.451	%Cu.M	12047.00	54.36
2	Single brick flat soling of picked jhama bricks including ramming and dressing bed to proper level and filling joints with powdered earth or local sand P.no-11, I-1	1.00	0.95		0.950	Sq.M	377.00	358.15
3	Cement concrete with graded jhama Khoa ballast (30 mm size) excluding shuttering. In ground floor and foundation (a) 6:3:1 proportion.	1.00	0.95	0.100	0.095	Cu.M	5803.06	551.29
4	Brick work with 1st class bricks in cement mortar (4 :1). a) In foundation & Plinth P.no-29, I-21(a)	1.00	0.25	0.600	0.150	Cu.M	6068.00	910.20
5	Plaster (to wall, floor, ceiling etc.) with sand and cement mortar including rounding off or chamfering corners as directed and raking out joints or roughening of concrete surface including throating, nosing and drip course where necessary. (Gr.floor). i) With 4:1 cement mortar. a) 20 mm. Thick plaster. P.no-151, I-2(a)	1.00	1.1		1.100	Sq.M	206.00	226.60
6	Neat cement punning above 1.5 mm thick in wall, dado, windowsills, floor, drain etc. P.no-152, I-8	1.00	1.100		1.100	Sq.M	38.00	41.80
7	Artificial stone in floor dado staircase etc. with cement concrete 1:2:4 with stone chips laid in panels as directed with topping made with ordinary or white cement (as measured) and marble dust in porportion (2:1) including smooth finishing and round P.no-40, I-3(ii)	1.00	0.300		0.300	Sq.M	303.00	90.90
8	Removal of rubbish, earth etc. from the working site and disposal of the same beyond the compound in conformity with the Municipalpaal /Corporation Rules fors such disposal, loading into truck and cleaning the site in all respect as per direction of Engineer - in -Charge P.no-9, I-13	1.00	0.800	0.475	0.3800	Cu.M	168.00	63.84
Total=								2,297.14
Total=								2,297.00

P. Basu
S.A.E.(HFA)
ASSISTANT
MUNICIPAL

123

22-12-'18

Executive Engineer
Siliguri Municipal Corporation
Siliguri

Commissioner
Siliguri Municipal Corporation

III. Year-wise Proposed Interventions in Slums

Year	Number of Beneficiaries and Central Assistance Required (Rs. in Crores)						Affordable Housing in Partnership						Total	
	Redevelopment thru Private Partner Participation*			Beneficiary-led Construction			Credit Linked Subsidy**			Affordable Housing in Partnership			No. of Beneficiaries	Amount
No. of Slums	No. of Beneficiaries	Amount	No. of Slums	No. of Beneficiaries	Amount	No. of Slums	No. of Beneficiaries	Amount	No. of Slums	No. of Beneficiaries	Amount	No. of Beneficiaries	No. of Beneficiaries	Amount
NIL	NIL	NIL	108	1645	24.68				6	1010	0.09	2655	24.77	
2016-17	NIL	NIL	108	4459	66.89	19	205		2	1149	17.24	5813	84.12	
2017-18	NIL	NIL	108	4084	61.26	9	112		11	1060	15.90	5256	77.16	
2018-19	NIL	NIL	108	3529	52.94	27	264		7	1115	16.73	4908	69.66	
2019-20	NIL	NIL	108	3250	48.75				7	1106	16.59	4356	65.34	
2020-21	NIL	NIL	108	2680	40.20				10	917	13.76	3597	53.96	
2021-22	NIL	NIL	108	19647	294.705	NA	581	0	NA	6357	80.295	26585	375.00	
Total	0	0	0.00	NA	0									

* Each beneficiary at the rate of one lakh each, ** Each Beneficiary at the rate of 1.5 lakh each, *** Just put number of beneficiaries, amount is not required, **** Affordable Housing in Partnership @ 1.5 lakh each

G. Basak
Executive Engineer
Siliguri Municipal Corporation
Siliguri

Commissioner
Siliguri Municipal Corporation

Year	Beneficiary-led Construction		Credit Linked Subsidy		Affordable Housing In Partnership		Future Urban Poor Projection		Total	
	No. of Beneficiaries	Amount	No. of Beneficiaries	Amount	No. of Beneficiaries	Amount	No. of Beneficiaries	Amount	No. of Beneficiaries	Amount
2016-17	355	5.32	0	0.00	0	0.00	112	1.68	466.76	5.32
2017-18	421	6.32	55	0.00	0	0.00	112	1.68	588	6.32
2018-19	416	6.24	24	0.00	0	0.00	112	1.68	552	6.24
2019-20	395	5.93	8	0.00	0	0.00	112	1.68	515	5.93
2020-21	379	5.69	0	0.00	0	0.00	112	1.68	491	5.69
2021-22	401	6.02	0	0.00	0	0.00	112	1.68	513.24	6.02
Total	2367	35.51	87	0.00	0	0.00	672	10.08	3126	35.51

IV. Year-wise Proposed Interventions for Other Urban poor based on demand survey NON SLUM

Number of Beneficiaries and Central Assistance Required (Rs. In Crores)

Silguri Municipal Corporation
Commissioner
Silguri Municipal Corporation
Chairman
Executive Engineer
Silguri Municipal Corporation
Silguri

G. G. Sarker and D.

V. Year-wise targets under different components	Number of Beneficiaries and Central Assistance Required (Rs. In Crores)										Total	
	2016-17		2017-18		2018-19		2019-20		2020-21			
	No.	Amount	No.	Amount	No.	Amount	No.	Amount	No.	Amount		
Interventions	No.	NL	NL	NL	NL	NL	NL	NL	NL	NL	NL	
Redevelopment through Private Participation	Slums	1645	24.68	4459	66.89	4084	61.26	3529	52.94	3250	48.75	
Subsidy for beneficiary-led improvement of existing house	Non-Slums	355	5.32	421	6.32	416	6.24	395	0.00	379	5.69	
Credit linked subsidy to individual beneficiaries	Slums	0	0.00	205	0.00	112	0.00	264	0.00	0	0.00	
Affordable Housing in Partnership (AHP)	Non-Slums	1010	15.15	1149	17.24	1060	15.90	1115	16.73	1106	16.59	
Additional Urban poor HH Projected (AHP)	Future urban poor	112	1.68	112	1.68	112	1.68	112	1.68	112	1.68	
Total		3176.76	46.8264	6370	92.115	5792	85.08	5415	71.34	4847	72.705	

V. Year-wise targets under different components	Number of Beneficiaries and Central Assistance Required (Rs. In Crores)										Total	
	2016-17		2017-18		2018-19		2019-20		2020-21			
	No.	Amount	No.	Amount	No.	Amount	No.	Amount	No.	Amount		
Interventions	No.	NL	NL	NL	NL	NL	NL	NL	NL	NL	NL	
Redevelopment through Private Participation	Slums	1645	24.68	4459	66.89	4084	61.26	3529	52.94	3250	48.75	
Subsidy for beneficiary-led improvement of existing house	Non-Slums	355	5.32	421	6.32	416	6.24	395	0.00	379	5.69	
Credit linked subsidy to individual beneficiaries	Slums	0	0.00	205	0.00	112	0.00	264	0.00	0	0.00	
Affordable Housing in Partnership (AHP)	Non-Slums	1010	15.15	1149	17.24	1060	15.90	1115	16.73	1106	16.59	
Additional Urban poor HH Projected (AHP)	Future urban poor	112	1.68	112	1.68	112	1.68	112	1.68	112	1.68	
Total		3176.76	46.8264	6370	92.115	5792	85.08	5415	71.34	4847	72.705	

V.
Commissioner
Siliguri Municipal Corporation
C.L.

G. G. Sarker and D.
Executive Engineer
Siliguri Municipal Corporation
Siliguri

UM BOUNDARY OF STILLIGURI MUNICIPALIT
(WARD NO - 1)



Ward No.- 2

HILL CART SWINGING ROAD
Mahabandha Prathamik Vidyalya

Ward No.- 45

Railway Power House ROAD
Jalpaiguri Development

Ward No.- 47

Railway Power House ROAD
Jalpaiguri Development

Ward No.- 3

Siliguri Junction Station
Siliguri Club Eye Hospital

Ward No.- 4

Banani Primary School
Banani Ghat

Executive Engineer
Siliguri Municipal Corpor

Commissioner
Siliguri Municipal Corpor

Slum location Map of
Siliguri Municipality


Prepared By :-
Data Soft Technology

Date : _____
Checked By : _____
Approved By : _____
Dated : _____

Ward Slum No.	Sl. No.	Slum Name
1	1	Kuli Para (Balendra Nagar)
2	2	Panchanan Colony (2)
3	3	Kuli Para (Dharma Nagar)
4	4	Panchanan Colony (1)
5	5	Rajan Lal Bastee
6	6	Ambdekar Nagar Colony
7	7	Harijan Bastee
8	8	B.R.I. Colony
9	9	Railway Bastee & Manksad Bastee
10	10	Mahamanda Colony
11	11	Khetdiram Colony
12	12	South Ambdekar Colony
13	13	Surya sen Colony (1)
14	14	Khudiram Colony (1)

SLUM BOUNDARY OF SILLIGURI MUNICIPALITY

(WARD NO - 2)

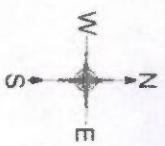


Ward No. - 45

Mr. D.

Executive Engineer
Siliguri Municipal Corporation
Siliguri

Mr. D.

Commissioner
Siliguri Municipal Corporation
Siliguri

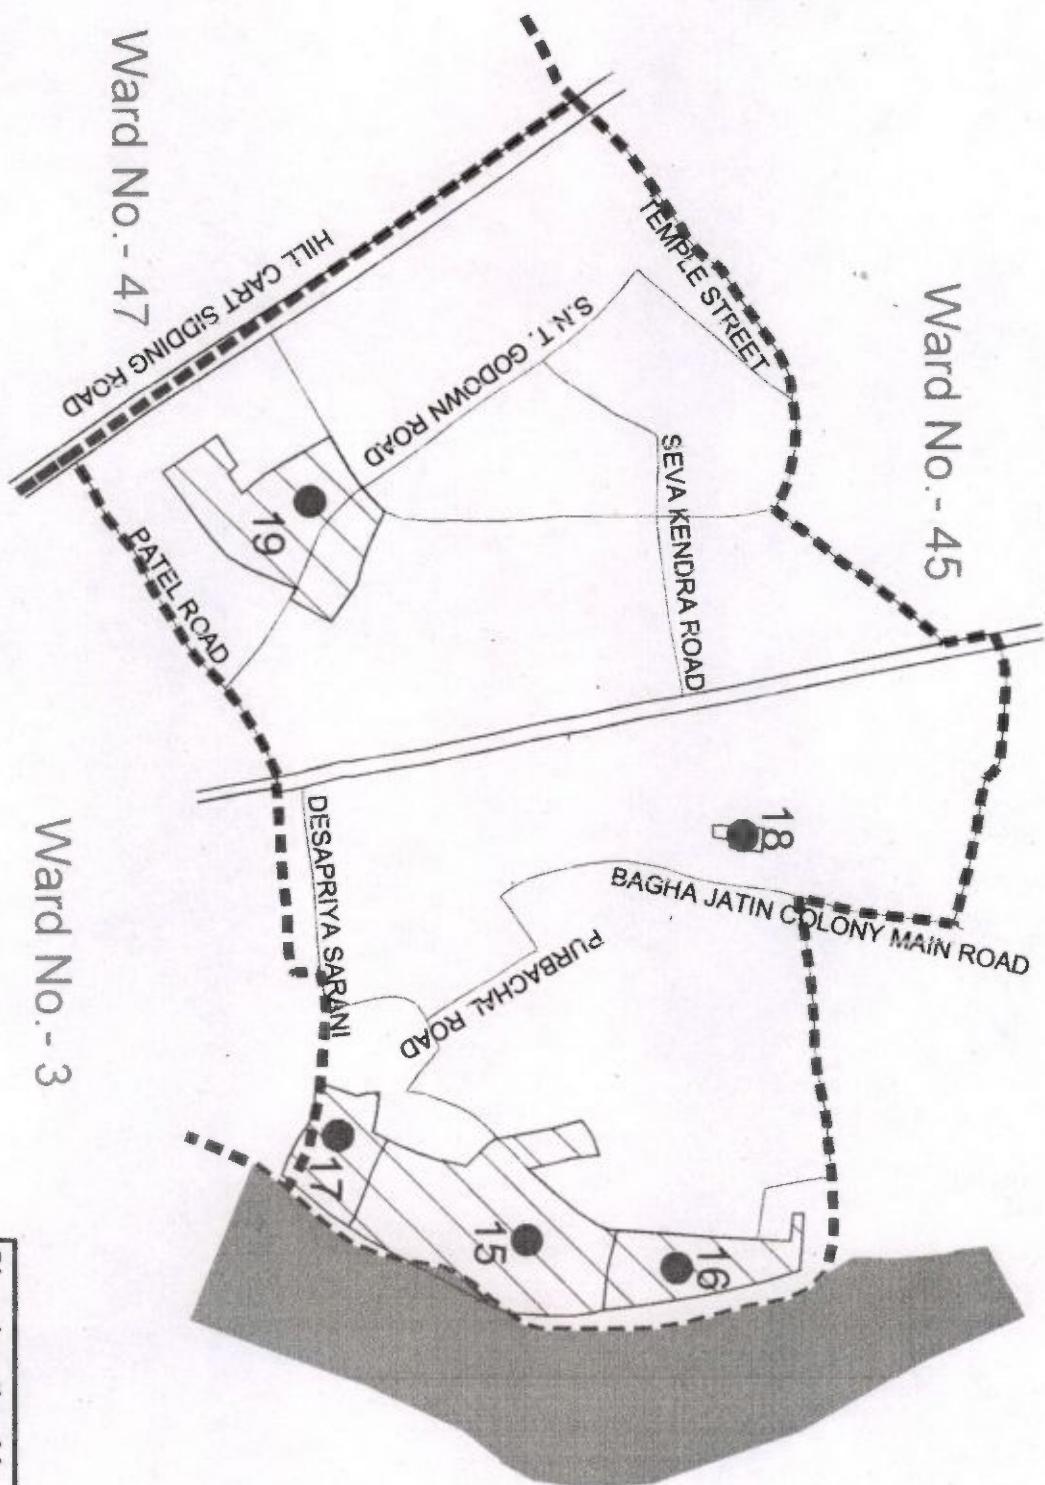

Ward No. - 3

Mr. D.

Commissioner
Siliguri Municipal Corporation
Siliguri

Slum location Map of
Siliguri Municipality

Prepared By :-

Data Soft Technology


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Checked By :

Approved By :

Ward	Slum Code	Sl. No.	Slum Name
14	15	East Baghajatin Colony	
15	16	Baghajatin Colony	
2	16	Purbanchal Jhup Colony	
17	18	Coch Bihar Colony	
18	19	Nepali Basti/BBD Colony	

SLL : BOUNDARY OF SILIGURI MUNICIPALITY
(WARD NO - 4)

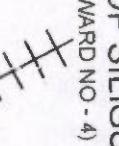


Ward No. - 1

Ward No. - 10

Ward No. - 6

Ward No. - 7

Ward No. - 5

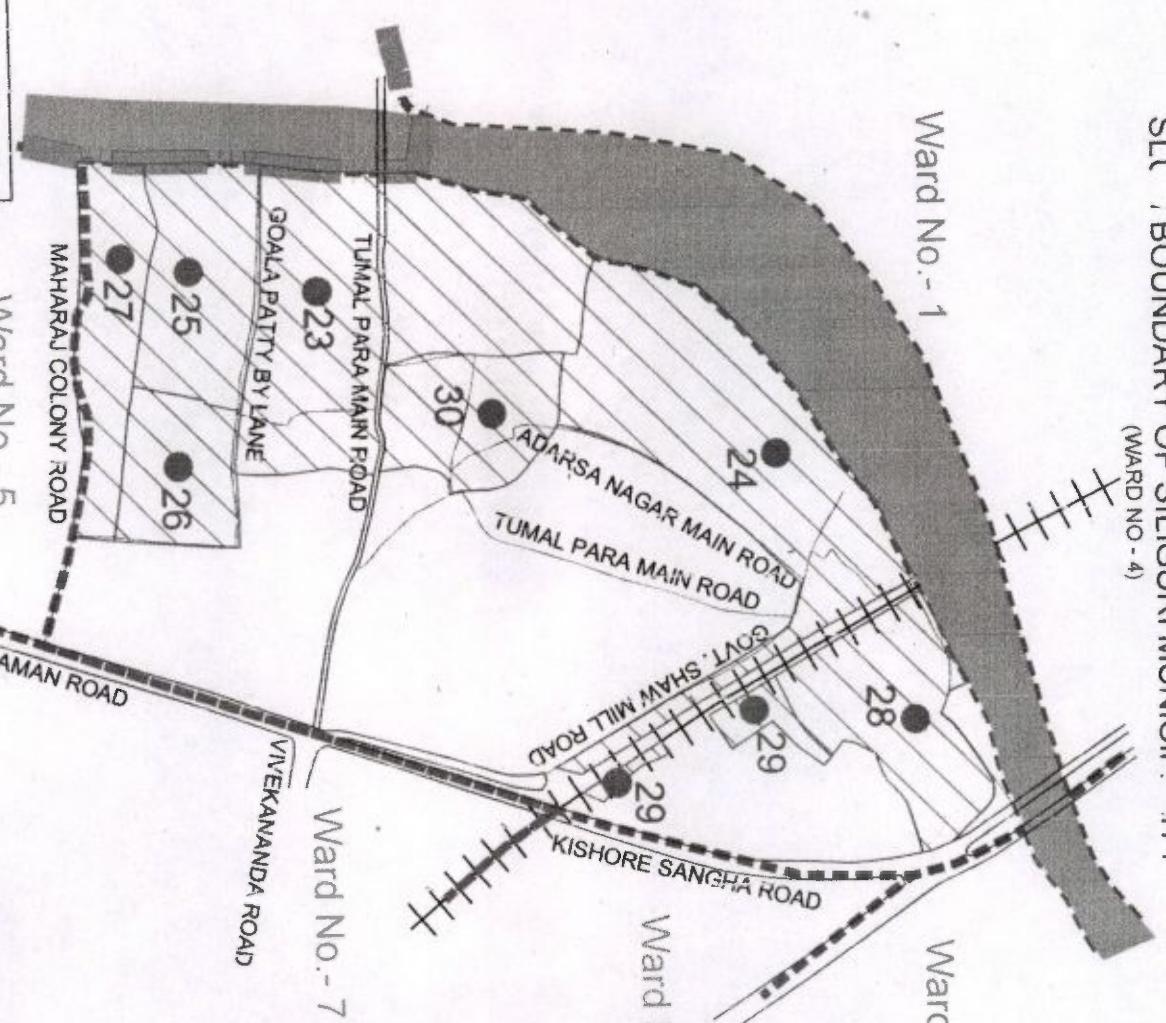

Executive Engineer
Siliguri Municipal Corporation
Siliguri

R. Basu
[Signature]

Commissioner
Siliguri Municipal Corporation
Siliguri

Prepared By :-
Data Soft Technology
S. Basu
Checked By : _____
Approved By : _____
Drawing No. : _____
Date : _____

Slum location Map of
Siliguri Municipality


Prepared By :-
Data Soft Technology

Scale : _____

Ward No.	Slum No.	Slum Name
22	23	Jyotinagar Colony
23	24	Adarsa Nagar Colony
24	25	Hemanta Basu Colony
25	26	Gowala Party
26	27	Maharaj Colony
27	28	Durgamagar Colony
28	29	Maizunder Colony
29	30	Tumal Para

SLUM BOUNDARY OF SILIGURI MUNICIPALITY


(WARD NO - 5)

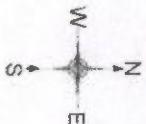

Ward No. - 4

Ward No. - 7

Ward No. - 9

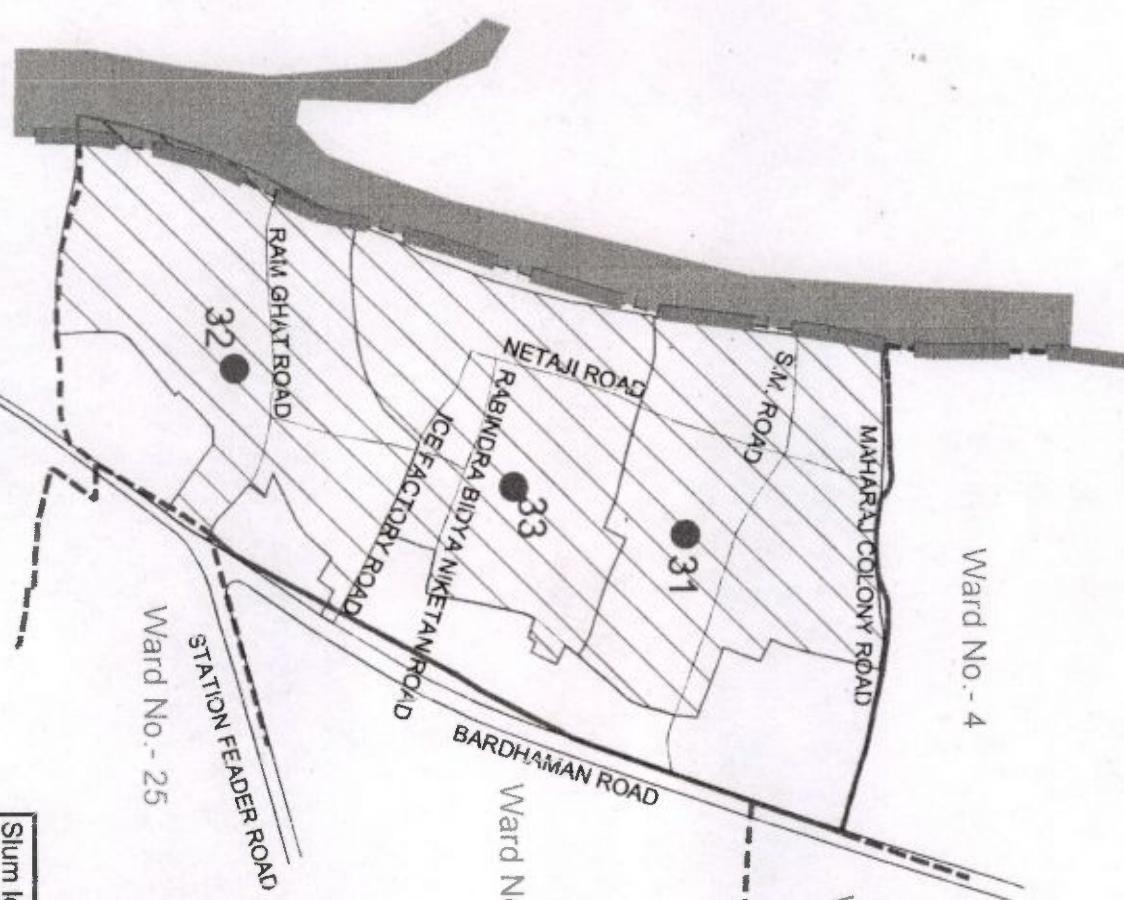

Slum location Map of
Siliguri Municipality

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Data Soft Technology

Checked By : _____
Drawing No. : _____
Date : _____


Siliguri
Municipal Corporation

Commissioner
Executive Engir
Siliguri Municipal Corporation
Siliguri

R. D. Basu

Ward No.	Slum Code	Sl. No.	Slum Name
30	31	Saritoshi Nagar	
5	31	Natun	
	32	Ganga	Ji

**SLUM BOUNDARY OF SILIGURI MUNICIPALITY
(WARD NO - 6)**

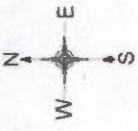


G. Gossu

D.

Executive En
Siliguri Municipal
Siliguri

Commissioner
Siliguri Municipal Corporation
W.W.

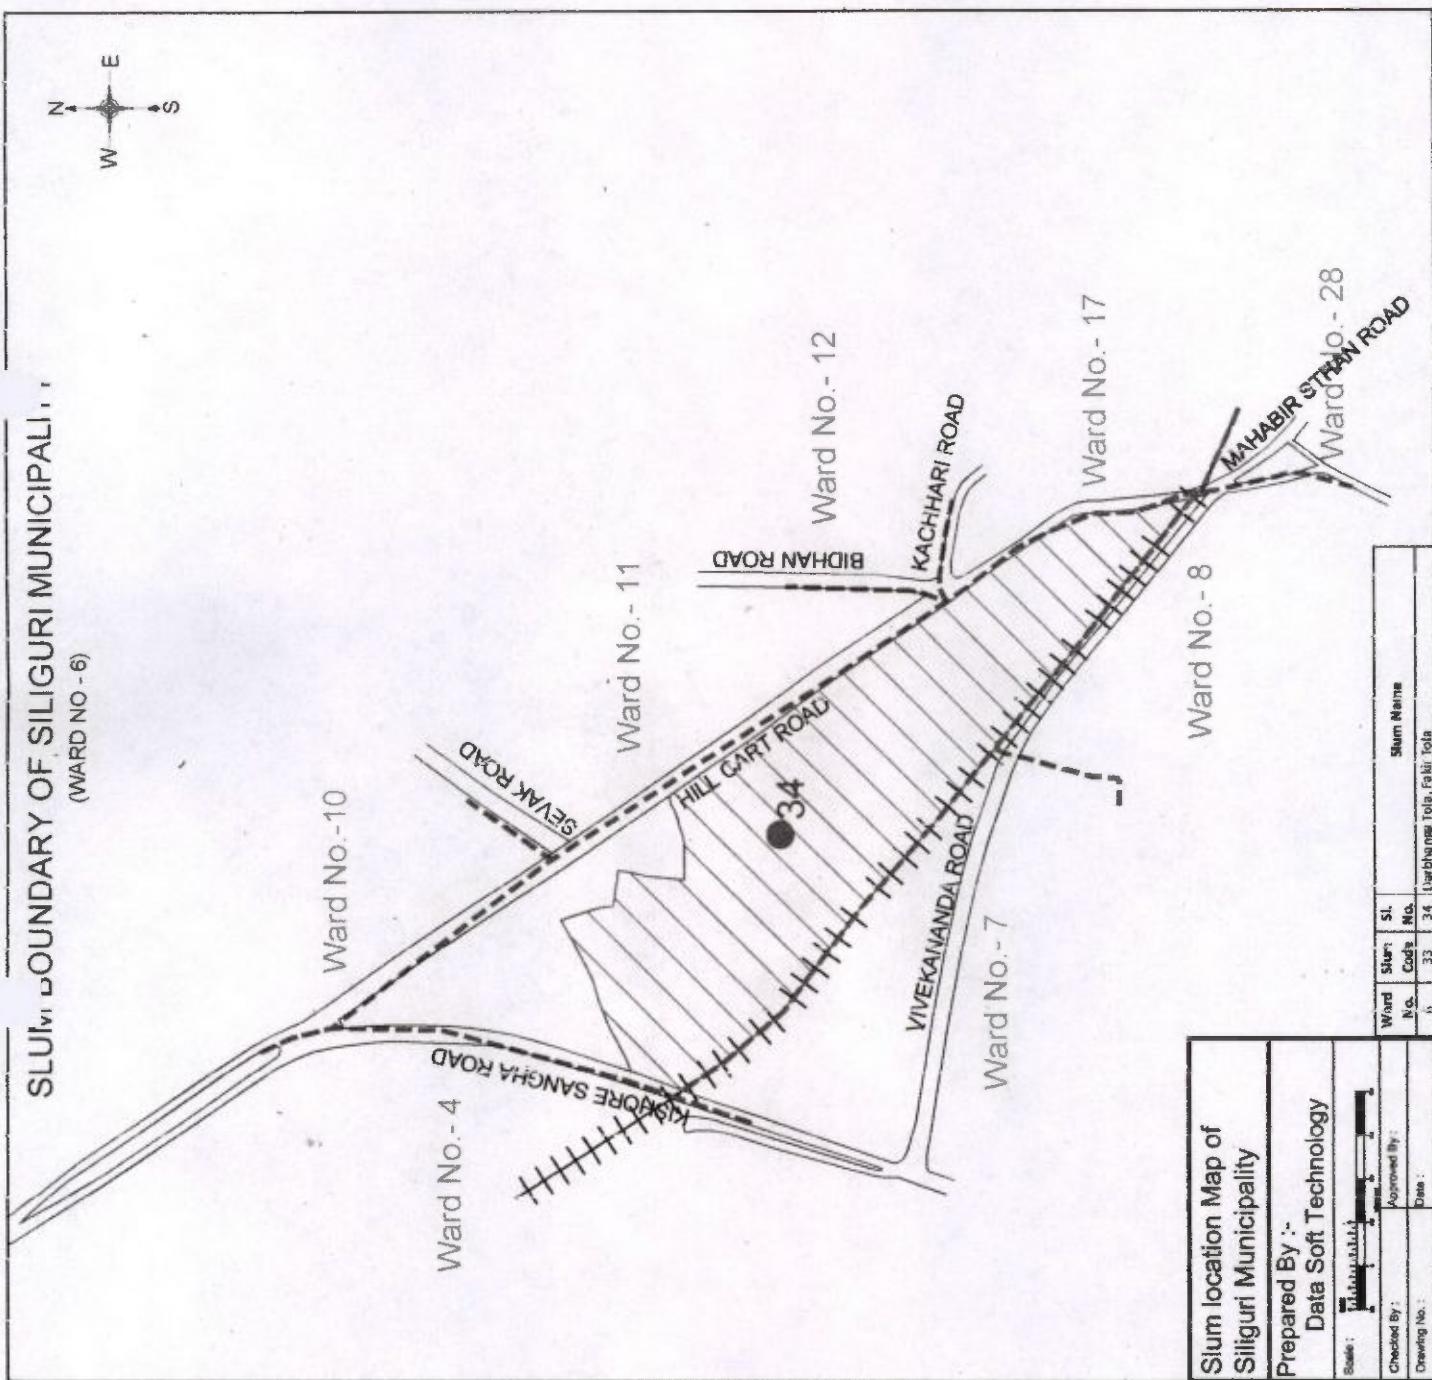

Slum location Map of
Siliguri Municipality



Prepared By :-
Data Soft Technology

Scale :	Approved By:	Date :
Checked By:	Name :	Date :
Drawing No.:	Slum Name:	Code No.:

33 34 Ward No. 10, Fakli, Tola

SLUM BOUNDARY OF SILIGURI MUNICIPALITY

(WARD NO - 7)

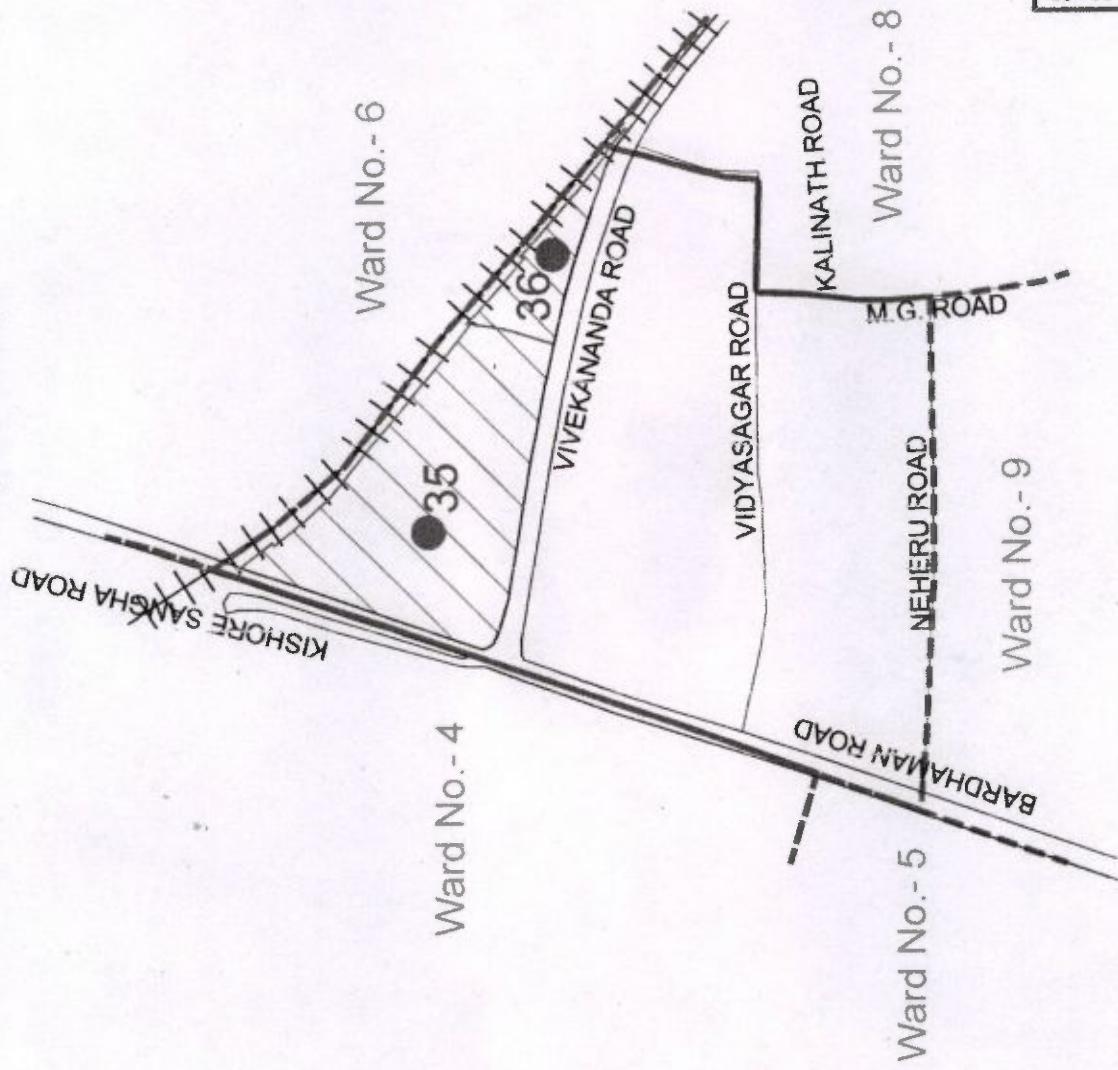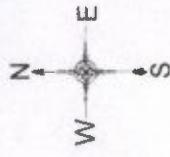

Executive Engineer
Siliguri Municipal Corporation

Commissioner
Siliguri Municipal Corporation

Slum location Map of
Siliguri Municipality



Prepared By :-
Data Soft Technology

Scale : 1 km

Checked By :
Approved By :
Drawing No. :
Date :

Ward No.	Slum Code	Sl. No.	Slum Name
7	34	35	Vivekananda Colony
	35	36	Swami Nagar

**SLUM F JNDARY OF SILIGURI MUNICIPAL Y
(WARD NO - 8)**

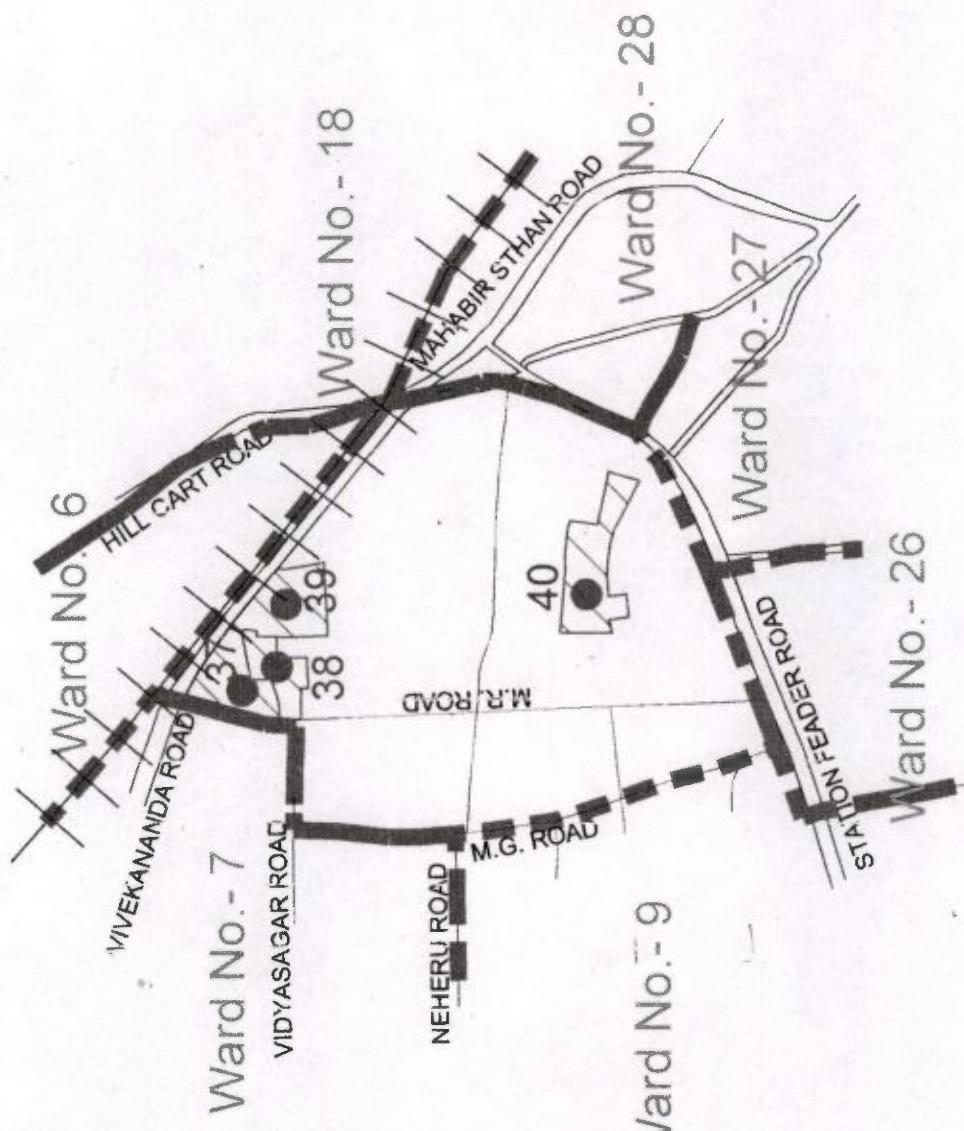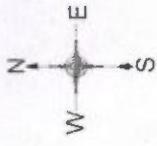


P. G. S.
Executive Engineer
Siliguri Municipal Corporation
Siliguri

Commissioner
Siliguri Municipal Corporation
Siliguri

Slum location Map of Siliguri Municipality	
Prepared By :-	Data Soft Technology
Scale :	1:1000000
Checked By :	Approved By :
Drawing No. :	Date :

Ward	Slum No.	Sl. Code No.	Slum Name
8	37	M.R. Road	
	38	12, Dayananda Marg	
	39	Koley Para	
	40	Dohabi Para	

SLUM | BOUNDARY OF SILIGURI MUNICIPALITY
(WARD NO - 10)

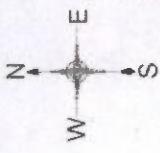

Ward No. - 44

Ward No. - 13

SEVOKE ROAD

Ward No. - 3

Executive Engineer
Siliguri Municipal Corp.
Siliguri

G. Basu

41

Ward No. - 14

NABIN SEN ROAD

CHURCH ROAD

Ward No. - 4

K.C. DEY ROAD

HILL CART ROAD

Ward No. - 11

KISHORE SANCHA ROAD

Ward No. - 6

	Slum Name		
Ward No.	Slum Code	Sl. No.	
10	36	41	Eidya Chakra Colony

Commissioner
Siliguri Municipal Corporation

Slum location Map of
Siliguri Municipality

Prepared By :-
Data Soft Technology


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Approved By :

Date :

**SLUM BOUNDARY OF SILEGURI MUNICIPALITY
(WARD NO - 14)**

(WARD NO - 14)

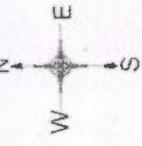

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Executive Engineer
Siliguri Municipal Corporation
Siliguri

Commissioner
Siliguri Municipal Corporat

This is a hand-drawn map of a slum area, likely in Siliguri, showing the boundaries of different wards and major roads. The map includes the following labeled features:

- Ward No.- 13**: Located on the left side.
- Ward No.- 10**: Located at the bottom center.
- Ward No.- 11**: Located at the bottom right.
- Ward No.- 12**: Located on the right side.
- Ward No.- 15**: Located on the far right.
- Ward No.- 39**: Located at the top center.
- Ward No.- 42**: Located between Ward 13 and Ward 39.

The map also shows several roads:


- LALALA RAJPATH ROY ROAD**: A road running vertically through Ward 13 and Ward 10.
- SEVOKE ROAD**: A road running diagonally from the bottom left towards the center.
- HABIB PARAPARA MAIN ROAD**: A road at the top.
- JATIN DAS SARANI**: A road connecting Ward 13 and Ward 15.
- NAJRUL SARANI**: A road connecting Ward 15 and Ward 12.
- HAREN MUKHERJEE ROAD**: A road on the far right.

A small rectangular box in the top right corner contains the following text:

Slum location Map of
Siliguri Municipality
Prepared By :-
Data Soft Technology

Ward No.	Slum Code No.	Sl. No.	Slum Name
14	42	42	Harijan Bustree (Astrom Para)

SLUM BOUNDARY OF SILIGURI MUNICIPALITY
(WARD NO - 18)

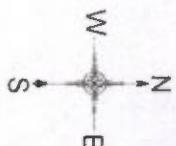

HILL CRAFT ROAD
BHIDHAN ROAD
KACHHARI ROAD

Ward No.- 12
Ward No.- 17
Ward No.- 19

BAGHA JATIN ROAD

KABIGURU ROAD

Ward No.- 8

NETAJI SUBHASH ROAD

Ward No.- 28
Ward No.- 17
Ward No.- 19

Ward No.- 20

NETAJI SUBHASH ROAD

Siliguri Municipal Corporation
G.E.C.

Executive Engineer
Siliguri Municipal Corp
Siliguri



R. Basu

Prepared By :-
Data Soft Technology
Scale :

Ward No.	Slum Code	Sl. No.	Slum Name
37	43	Sraban Nagar	
38	44	Lichu Bagan Colony	
18	39	Rana Bastee	
40	46	Kshudiram Colony	
41	47	Pramodnagar	

SLUM BOUNDARY OF SILIGURI MUNICIPALITY

(WARD NO - 19)

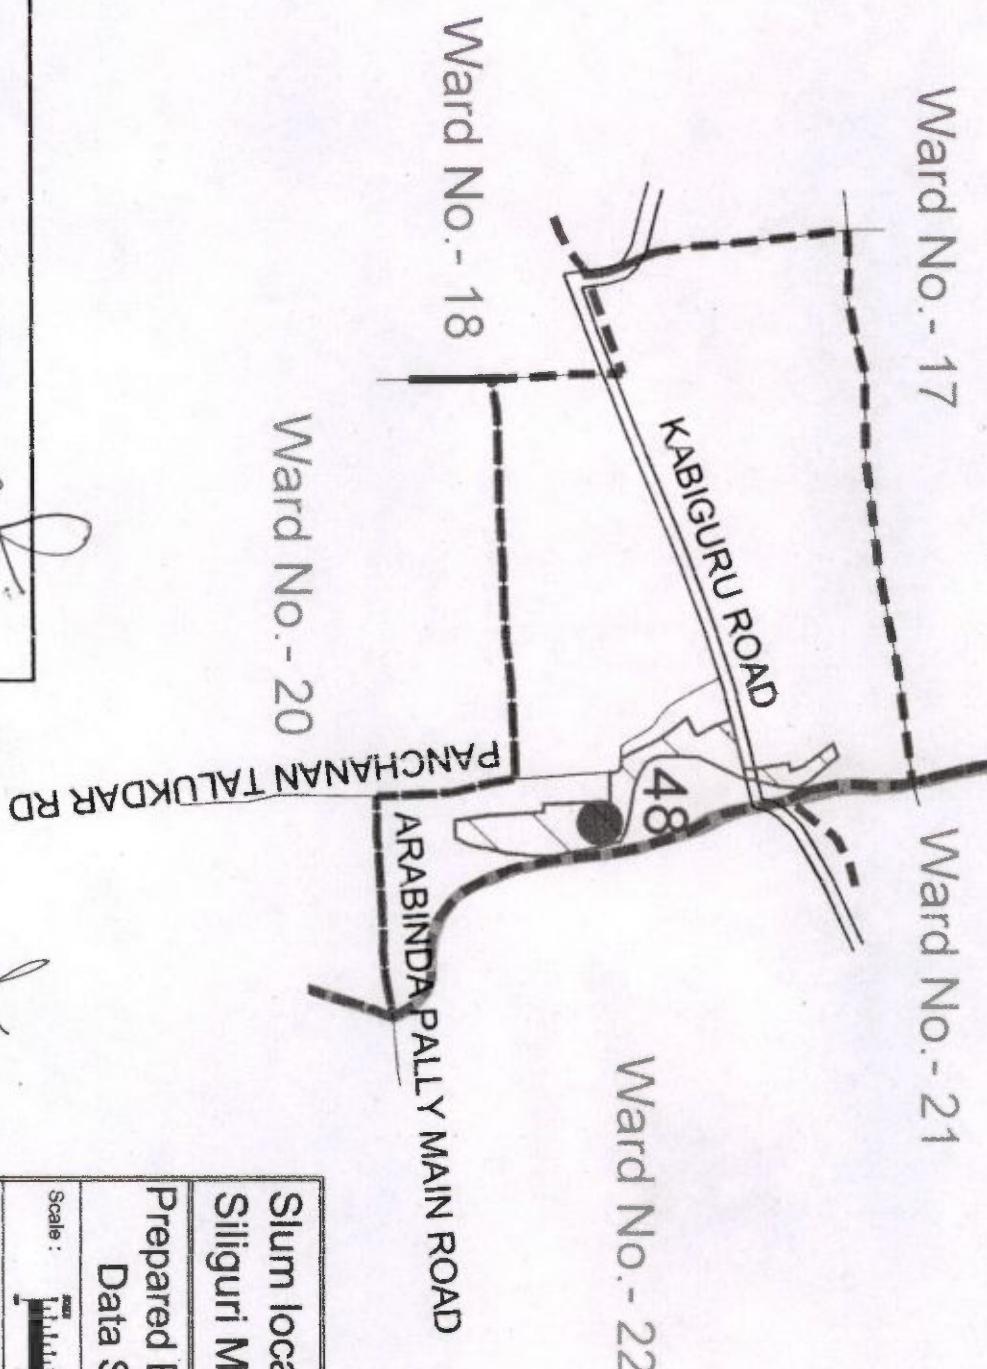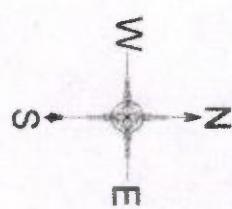

Slum location Map of
Siliguri Municipality

Prepared By :-

Data Soft Technology

Scale :

Checked By : Approved By :

Drawing No. : Date :

Ward No.	Slum Code	Slum Name
19	42	Subhashnagar
19	48	



P.B...

Executive Engineer
Siliguri Municipal Corporation

Commissioner
Siliguri Municipal Corporation

SLUM BOUNDARY OF SILIGURI MUNICIPALITY

(WARD NO - 20)

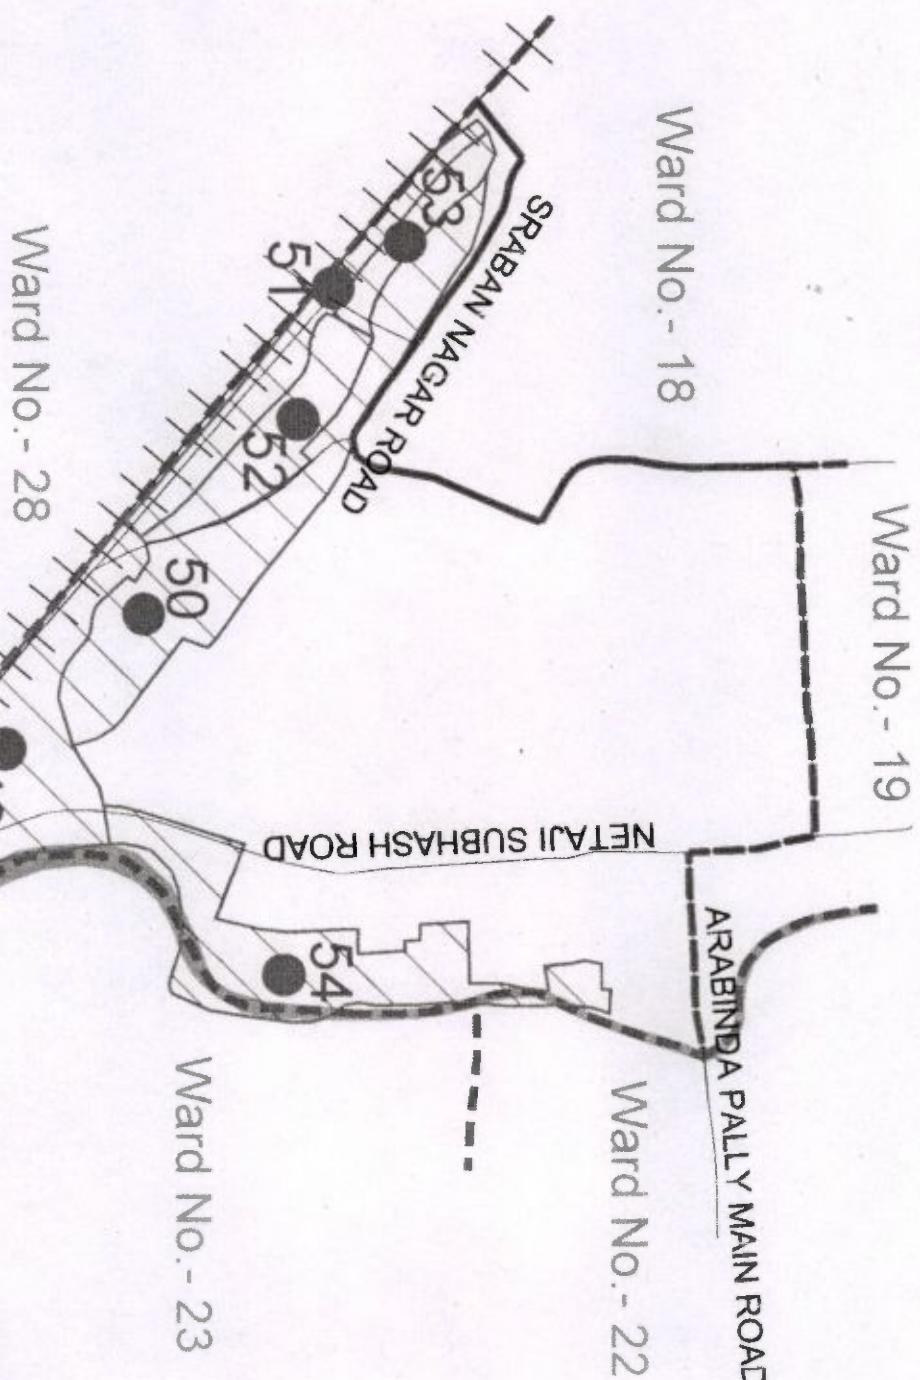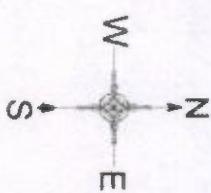

Slum location Map of
Siliguri Municipality

Prepared By :-

Data Soft Technology

Scale :

Checked By : Approved By :

Drawing No. :



Siliguri
Municipal Corporation

Executive Engineer
Siliguri Municipal Corporation

R. 350.

Ward No.	Slum Code	Slum No.	Slum Name
43	49	Durgadas Colony	
44	50	Jyotinagar Colony	
45	51	Chittaranjan Colony	
20	52	Ramnahan Colony	
46	53	Sraban Nagar Colony	
47	54	Fuleshwari Unnyan Colony	
48			

SLU BOUNDARY OF SILIGURI MUNICIPALITY
(WARD NO - 22)

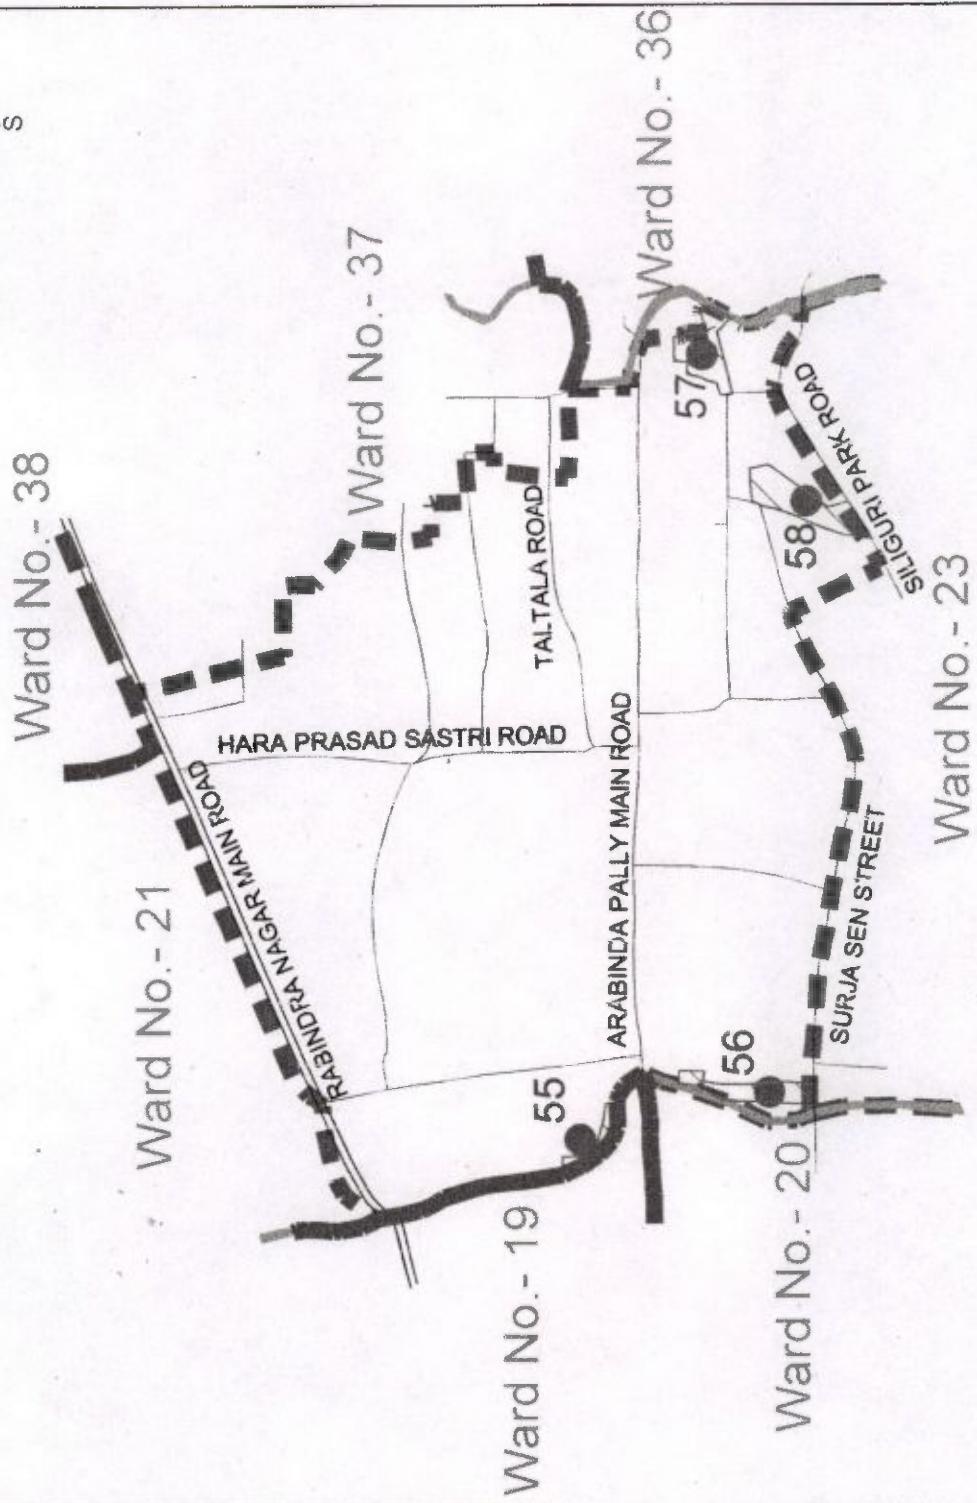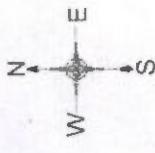

Ward No.	Slum Code No.	Sl. No.	Slum Name
22	55	Subashnagar Rathkhola	D
	56	Phuleshari Umnayan	and
	57	East Arobinda	and
	58	Dip Char	Executive Engineer
			Siliguri Municipal Corporation

Slum location Map of
Siliguri Municipality

Prepared By :-
Data Soft Technology

Approved By :-
Siliguri Municipal Corpora-



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[Signature]
Commissioner
Siliguri Municipal Corpora-
[Signature]

SLUM BOUNDARY OF SILIGURI MUNICIPALITY
(WARD NO - 23)



Slum location Map of
Siliguri Municipality

Prepared By :-

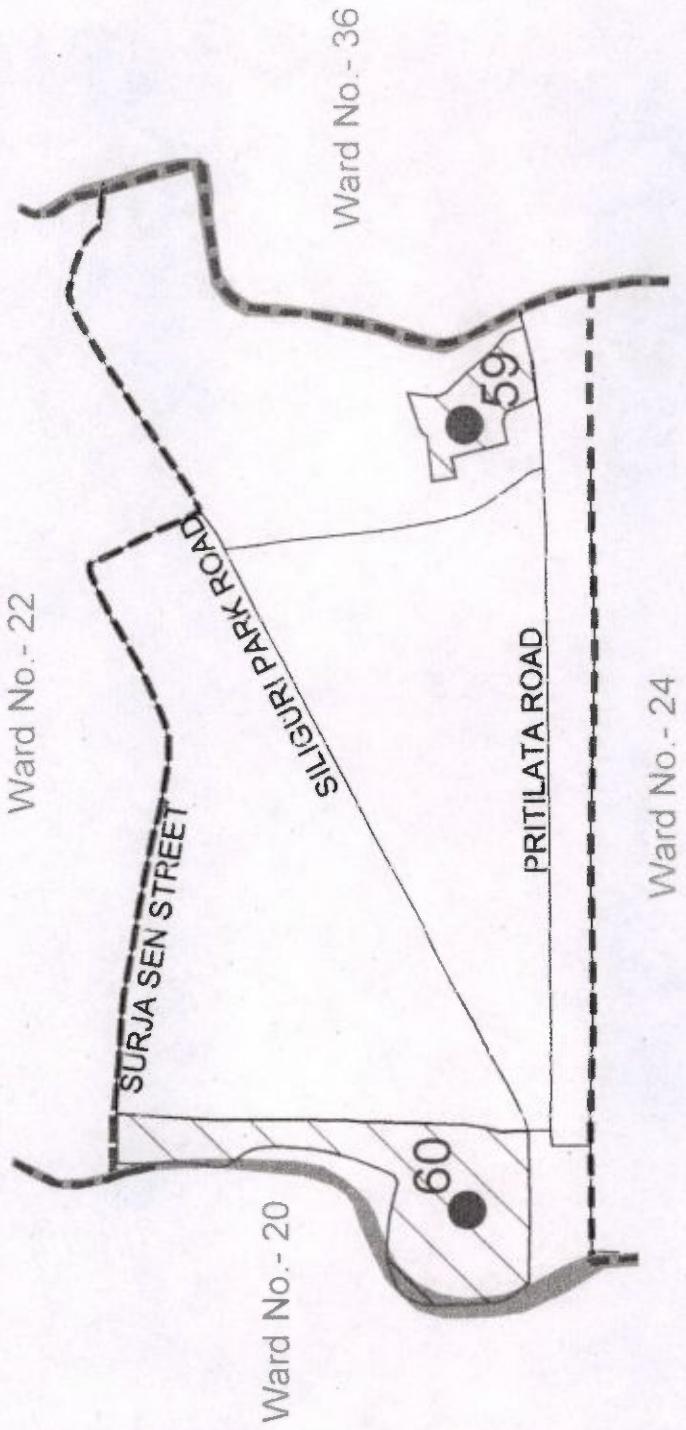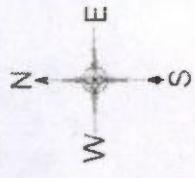Data Soft Technology

Scale :



Approved By :

Date :

Commissioner


Siliguri Municipal Corporati
on

Ward No.	Slum Code	Sl. No.	Slum Name
23	49	59	Udayan Colony
	50	60	Fuleshwari Unnyan Colony

Executive Engineer

SLUM BOUNDARY OF DANKUNI MUNICIPALITY

(WARD NO - 24)

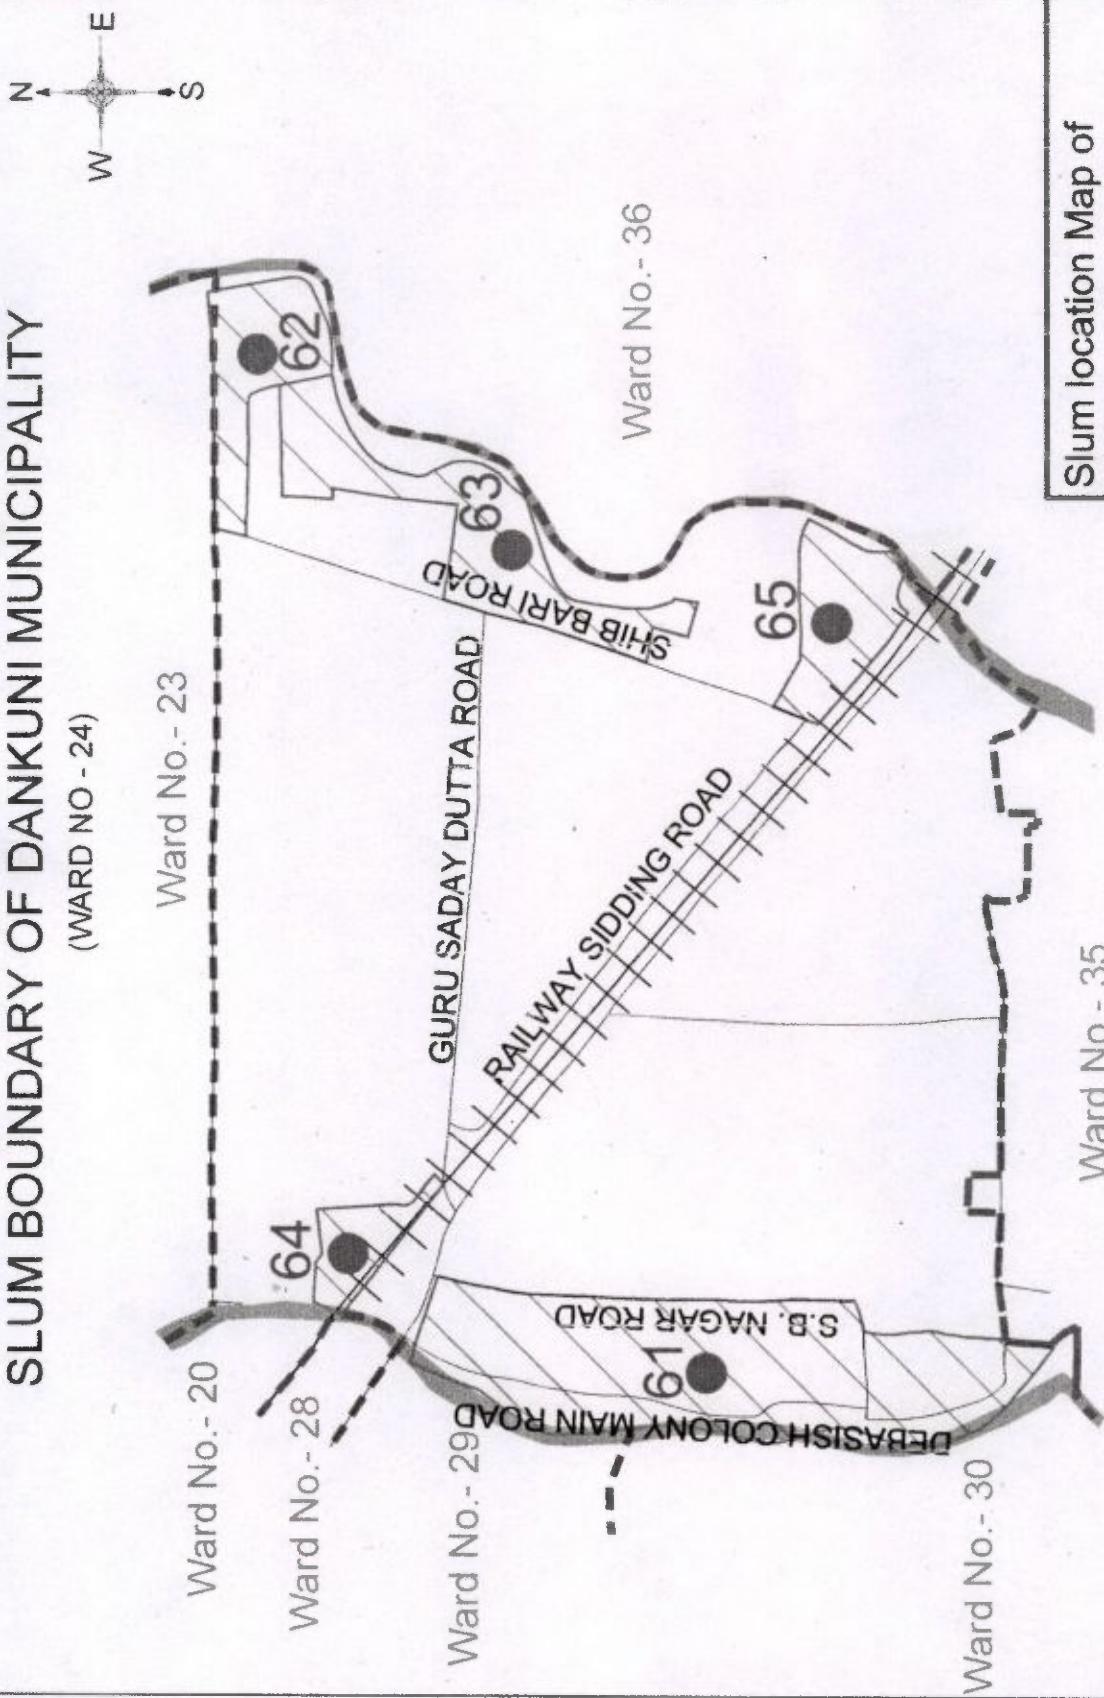

Slum location Map of Dankuni Municipality

Prepared By :-
Data Soft Techno


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Commissioner
Municipal Corporation
Singapore

Ward No.	Slum Code	Sl. No.	Slum Name
24	51	61	Debashish Colony
	52	62	Prantik Pally
	53	63	Sramiknagar Colony
	54	64	Fuleshwari Urnyan Colony
	55	65	Das Colony



SLUM BOUNDARY OF SILIGURI MUNICIPALITY

(WARD NO - 28)

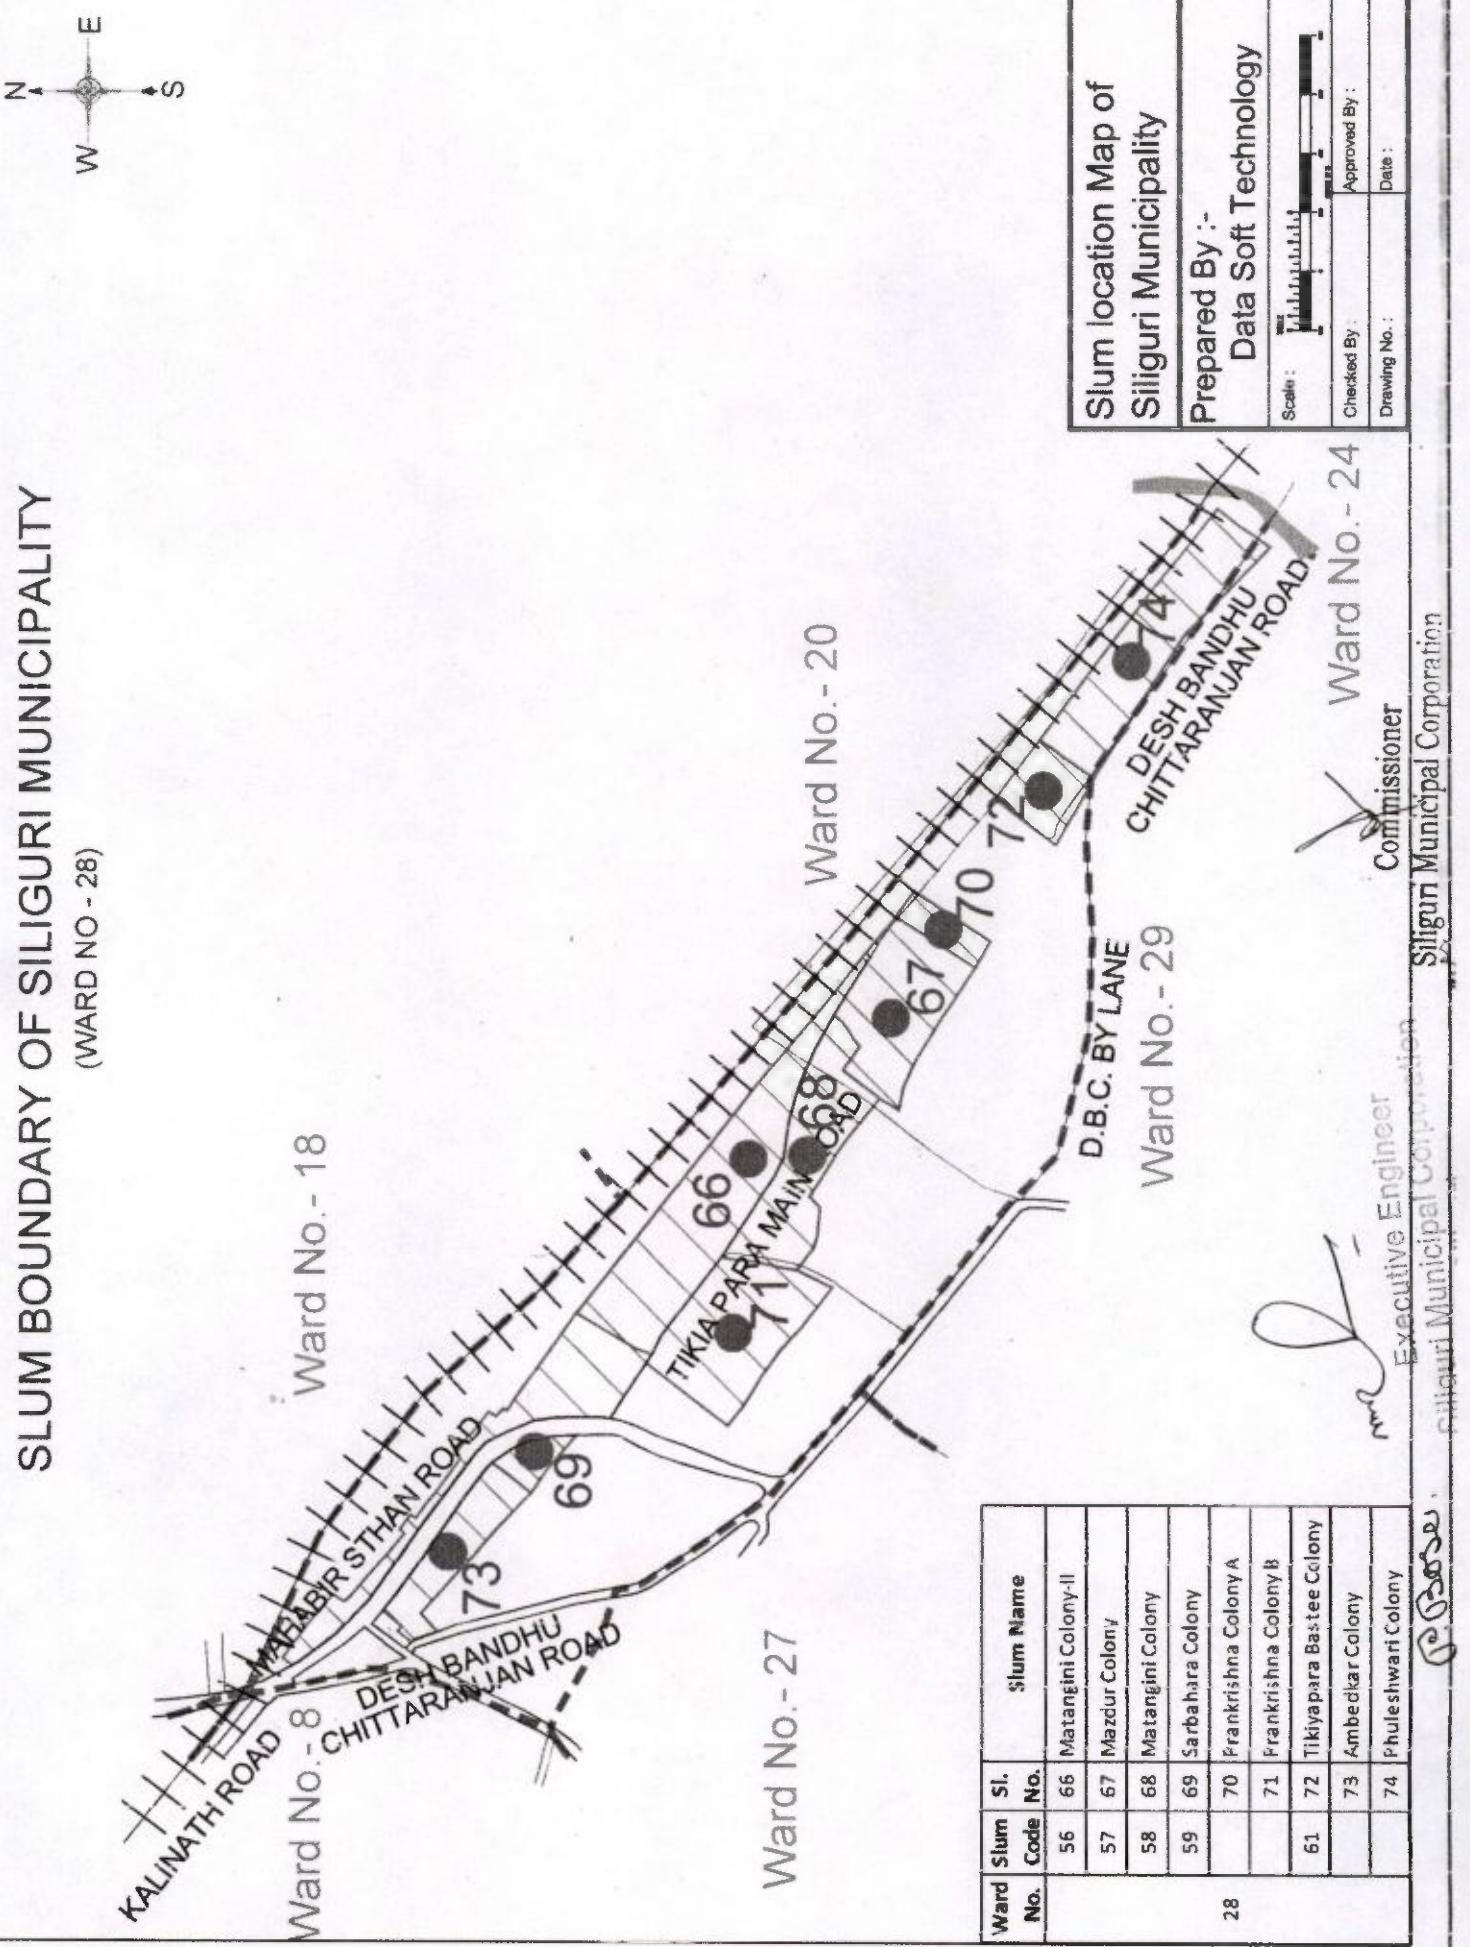

SLUM BOUNDARY OF SILIGURI MUNICIPALITY

(WARD NO - 29)

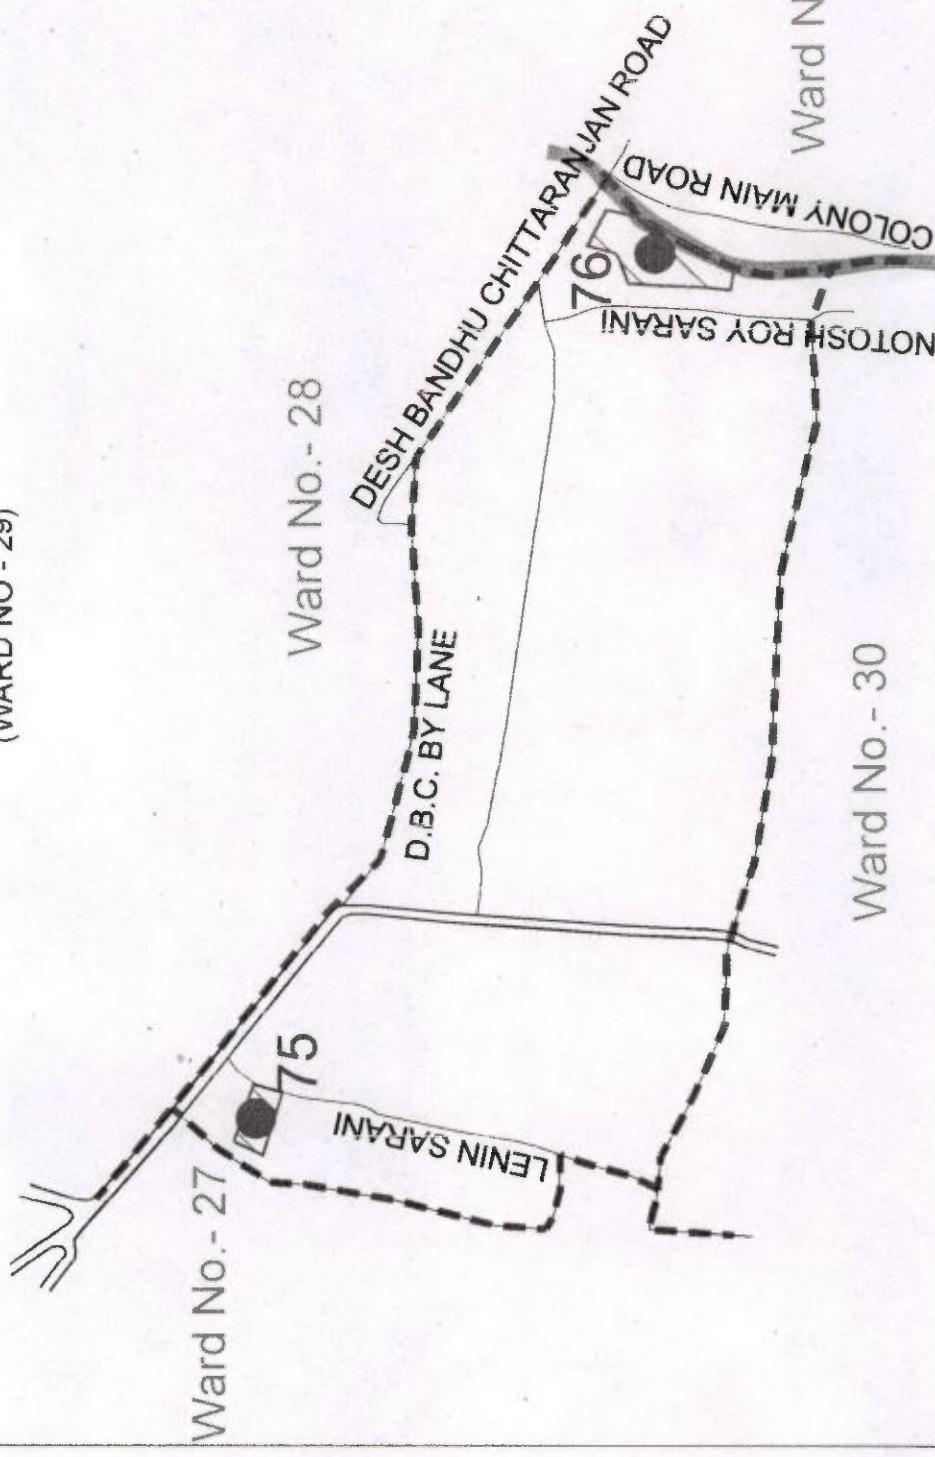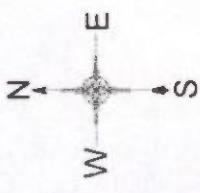

Slum location Map of
Siliguri Municipality

Prepared By :-
Data Soft Technology

Scale : Approved By :



Checked By : Drawing No. : Date :

Commissioner Executive Engineer
Siliguri Municipal Corporation Siliguri Municipal Corporation

Ward No.	Slum Code No.	Sl. No.	Slum Name
29	62	75	Samity Colony
	63	76	Fuleshwari Colony

SLUM BOUNDARY OF SILIGURI MUNICIPALITY

(WARD NO - 31)

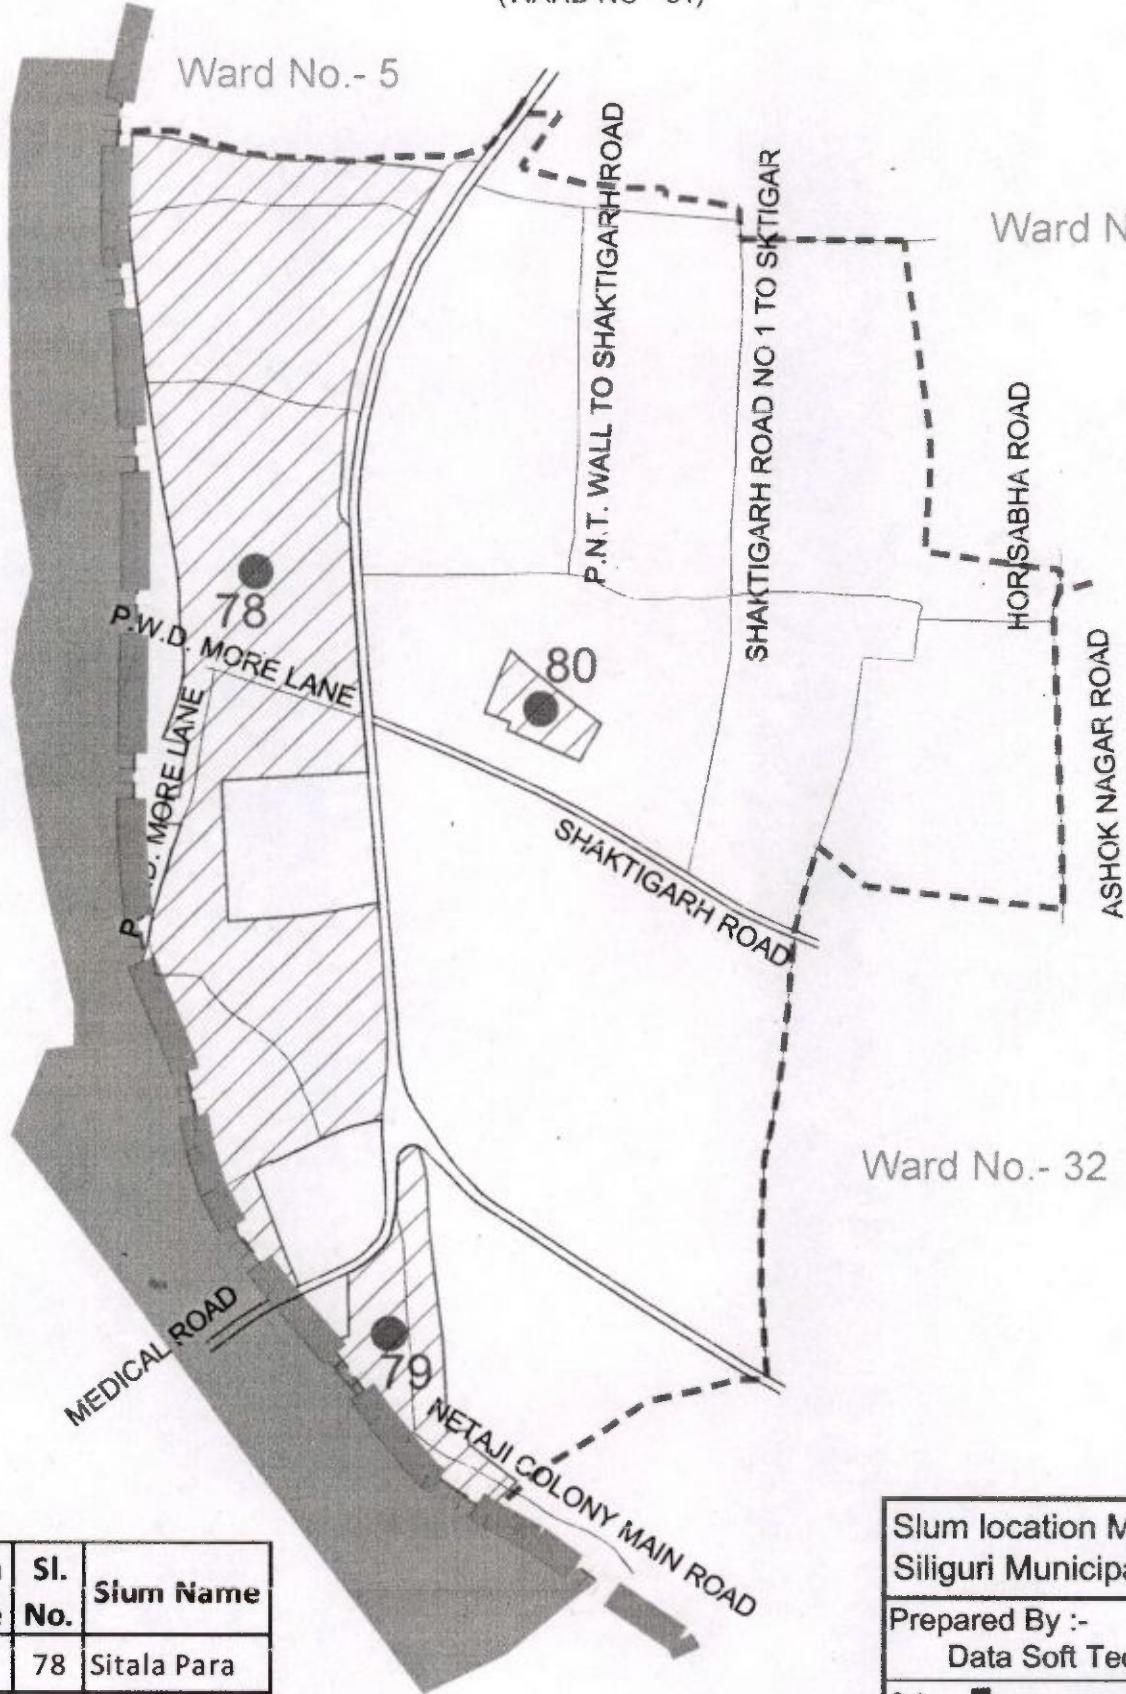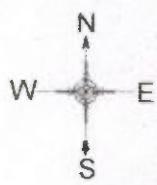

Ward No.	Slum Code	Sl. No.	Slum Name
31	65	78	Sitala Para
	66	79	Noukaghat
	67	80	Mia Bastee

Slum location Map of
Siliguri Municipality

Prepared By :-
Data Soft Technology

Scale :
Checked By : Approved By :
Drawing No. : Date :

Commissioner
Siliguri Municipal Corporation
[Signature]

Executive Engineer
Siliguri Municipal Corporation

SLUM BOUNDARY OF SILIGURI MUNICIPALITY
(WARD NO - 32)

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W


Ward No. - 25

Ward No. - 31

Sukana Pally Kali Mandir

Ward No. - 33

Ward No. - 34

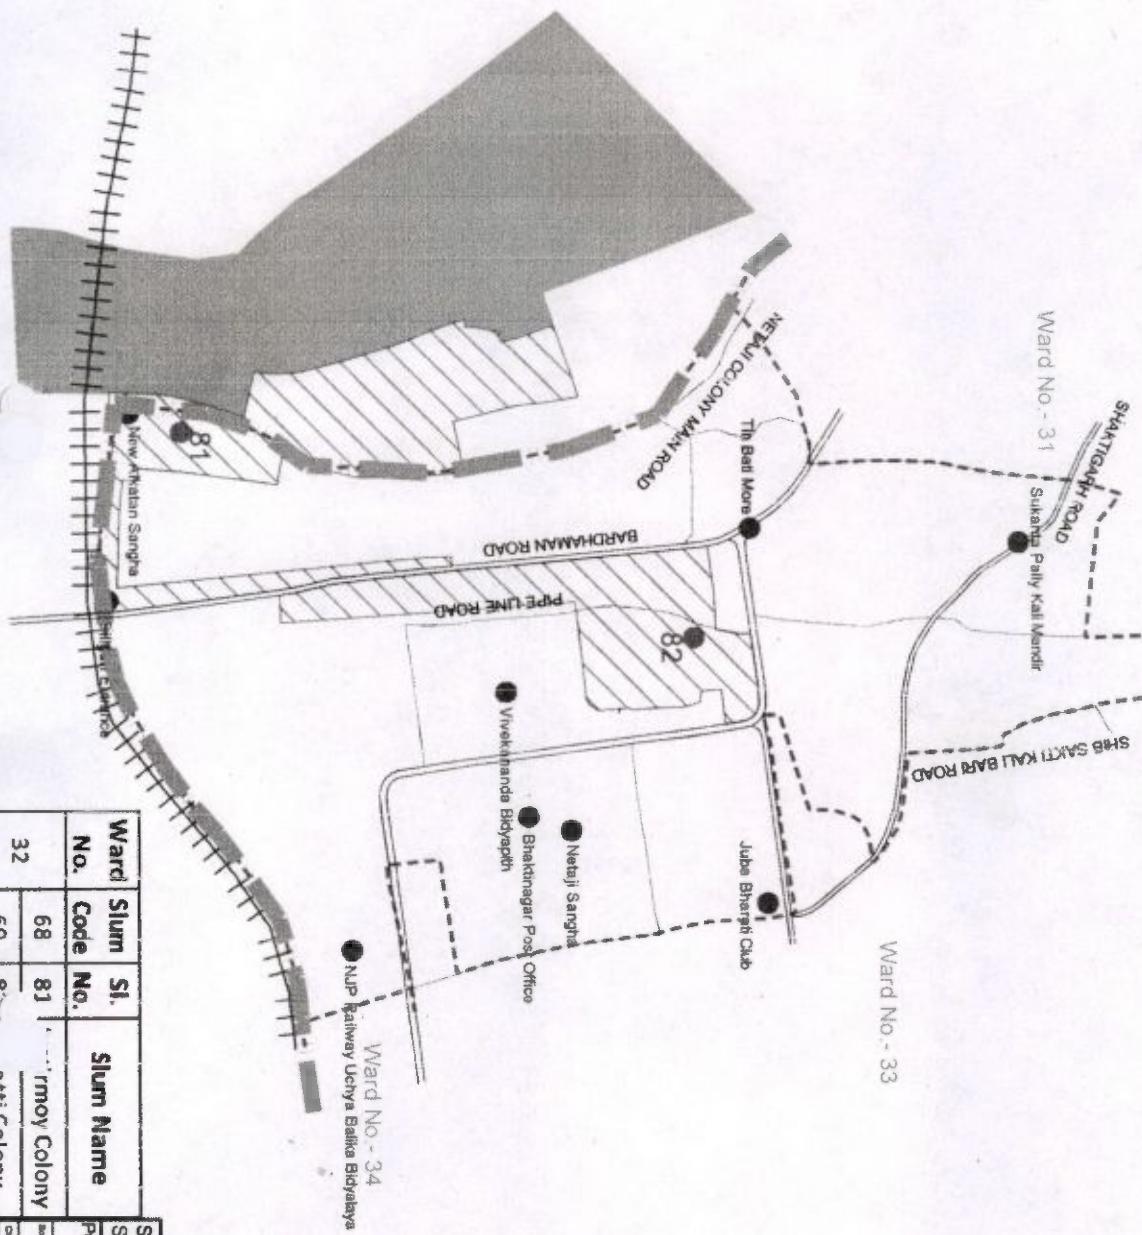

Ward No.	Slum Code No.	Sl. No.	Slum Name
68	81	1	rimoy Colony
32	69	2	mitti Colony
		3	Netaji Sangha
		4	Bhaktinagar Post Office
		5	Vivekananda Bhagapith
		6	Til Bell More
		7	Jube Bharati Club
		8	NUP Railway Uchya Balika Balakalya
		9	Netaji Sangha
		10	Bhaktinagar Post Office
		11	Vivekananda Bhagapith
		12	Til Bell More
		13	Jube Bharati Club
		14	NUP Railway Uchya Balika Balakalya

Commissioner
Siliguri Municipal Corporation

R.G.S.
Executive Engineer
Siliguri Municipal Corp
Siliguri

Slum location Map of
Siliguri Municipality

Prepared By :-

Data Soft Technology

Date : 10/08/2014


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SLUM BOUNDARY OF SILIGURI MUNICIPALITY

(WARD NO - 33)



Slum location Map of Siliguri Municipality

Prepared By :-
Data Soft Technology

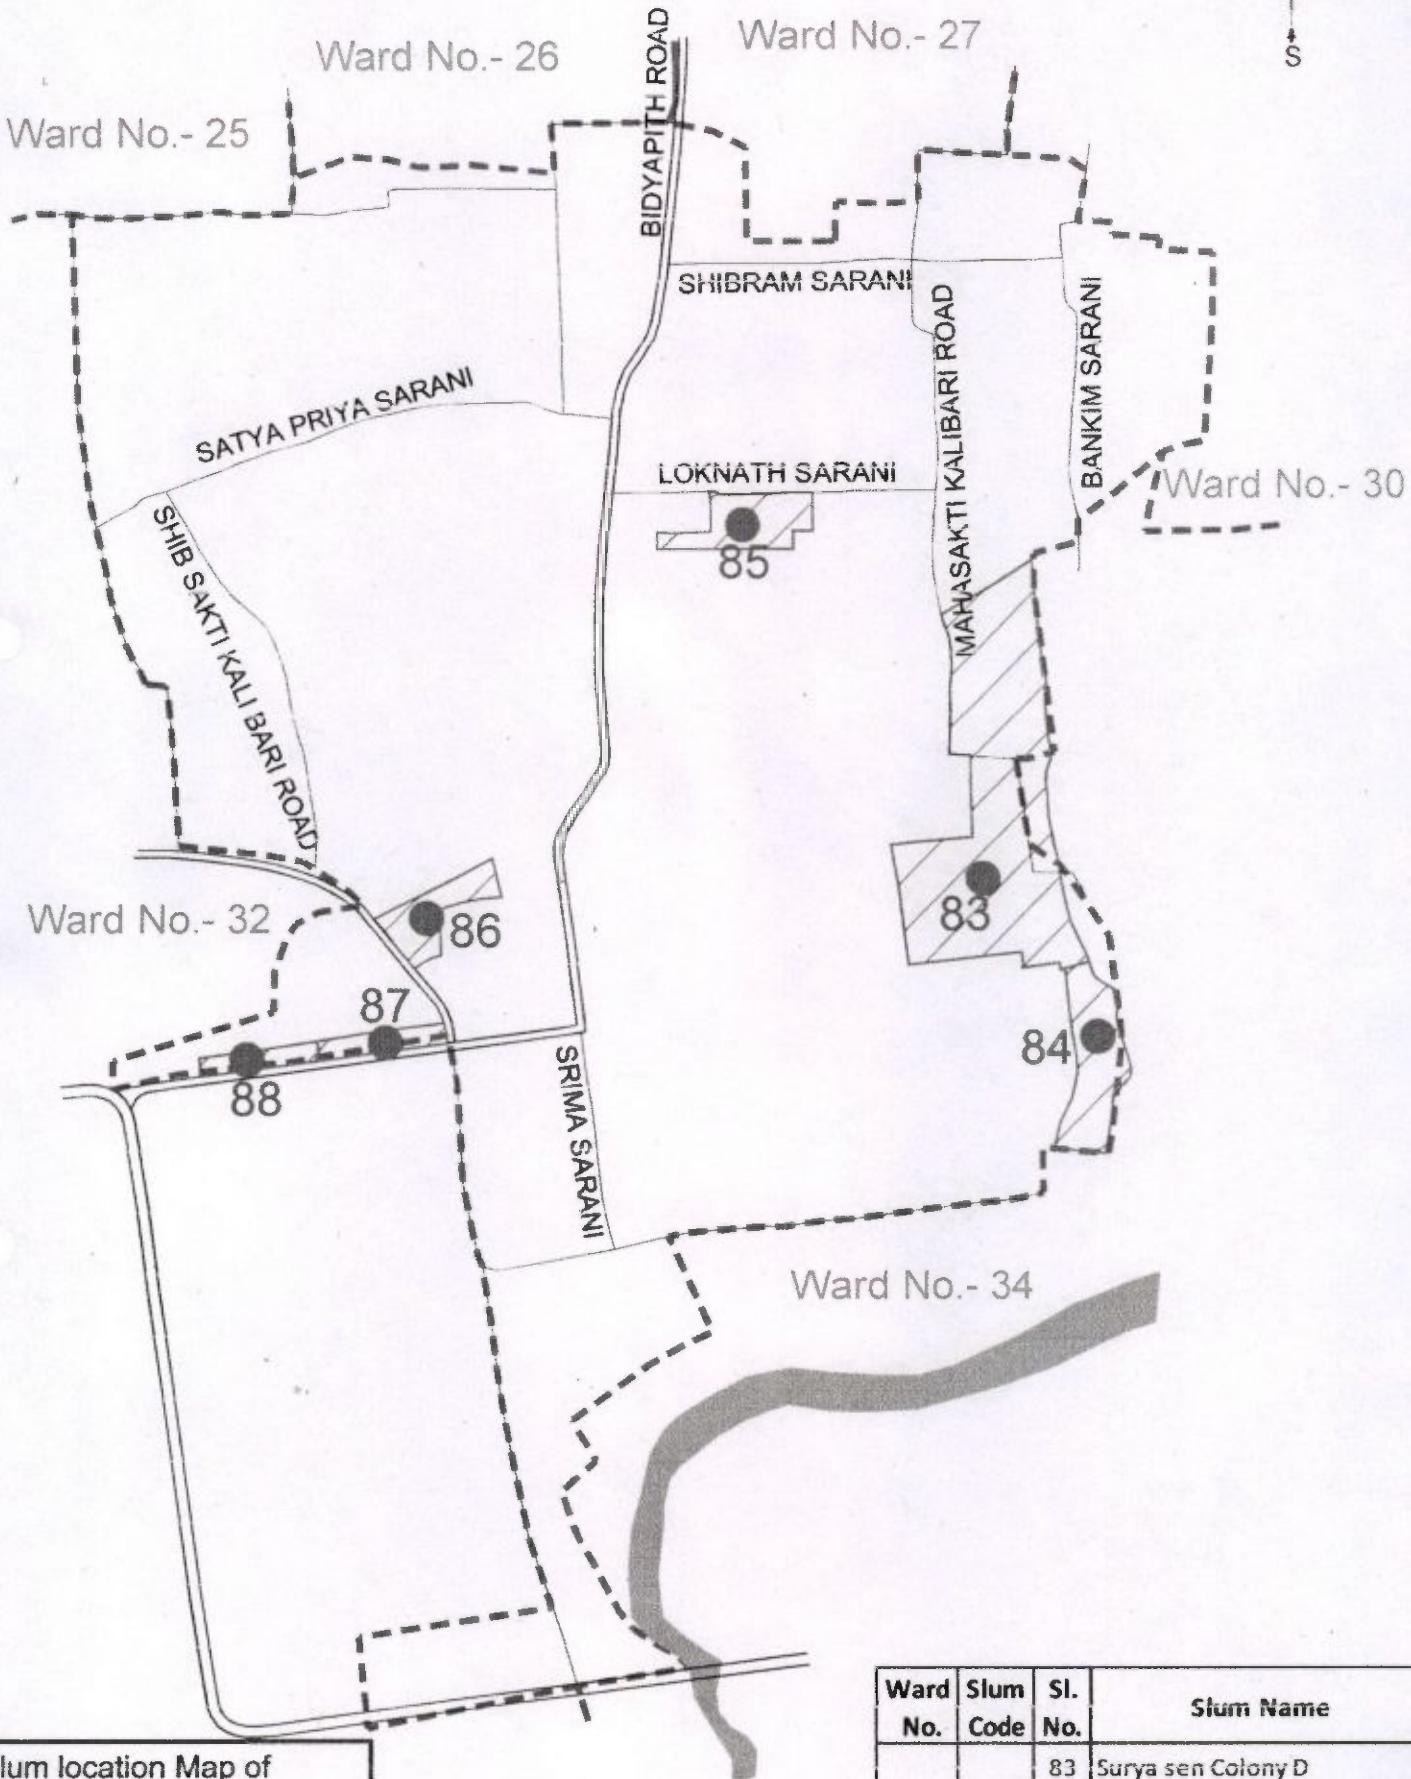Scale :

Checked By : Approved By :

Drawing No. : Date :



[Handwritten signatures]

Executive Engineer

Ward No.	Slum Code	Sl. No.	Slum Name
33		83	Surya sen Colony D
		84	Surya sen Colony E
	71	85	Mistripara
		86	Sing Para
		87	Sukanta Pally Hataath Colony
		88	NGC Colony Seamer

S M BOUNDARY OF SILIGURI MUNICIPALITY

(WARD NO - 34)

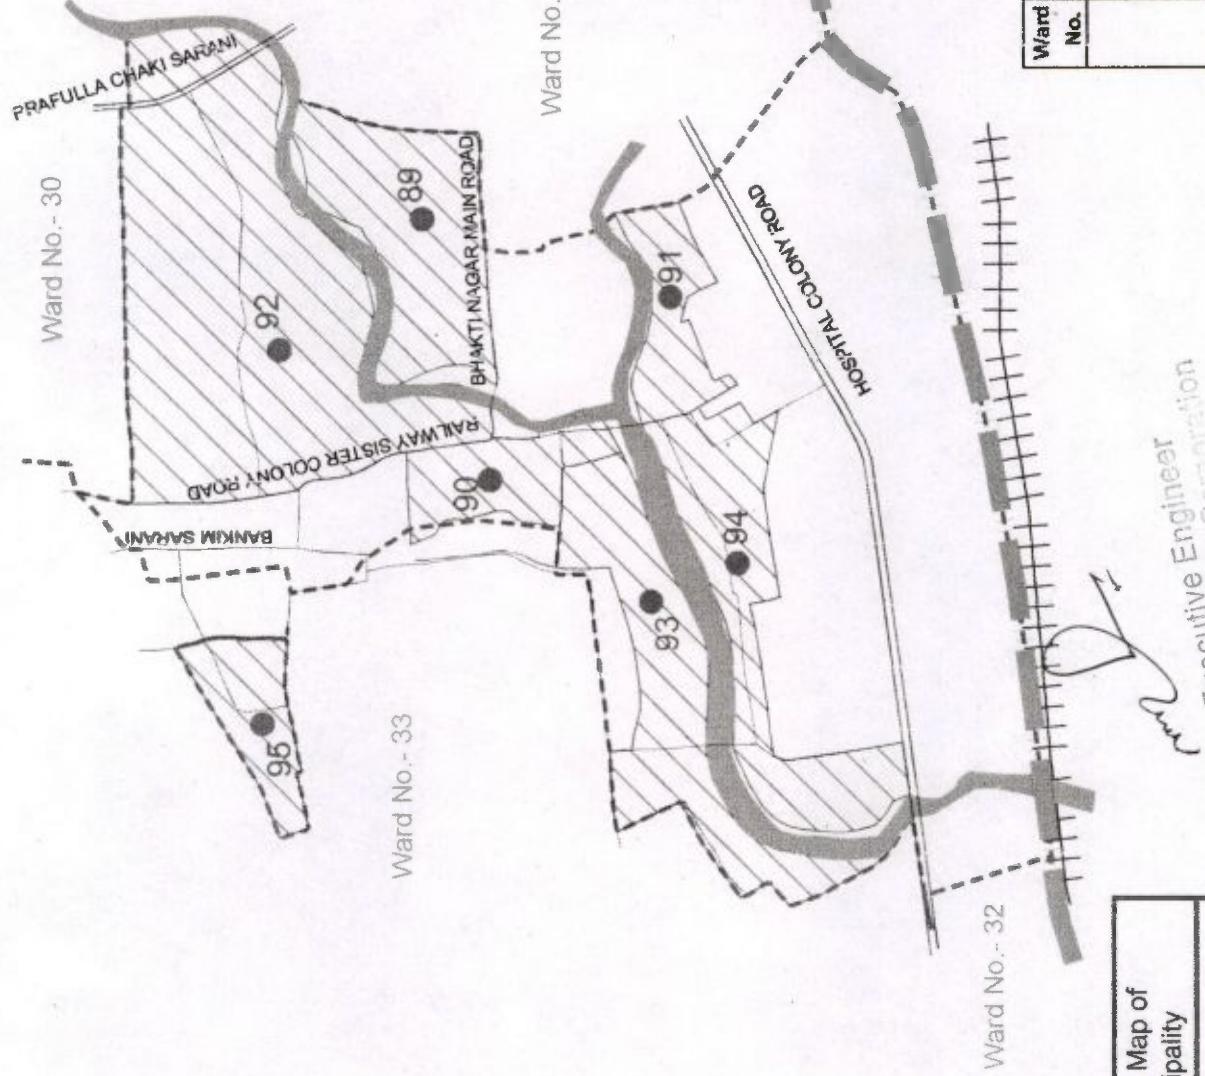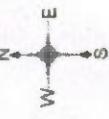

Ward No.	Slum Code	Sl. No.	Slum Name
74	89	89	Bhaktinagar
75	90	90	Surya Sen Colony Blok-C
79	91	91	D.S. Colony
34	92	92	Surya Sen Colony B
	93	93	Surya Sen Colony Block E-I
	94	94	Surya Sen Colony Block E-II
	95	95	Surya Sen Colony D


Executive Engineer
Siliguri Municipal Corporation
S.M.C. Siliguri Municipal Corporation
G. G. S.

Slum location Map of	Siliguri Municipality
Prepared By :-	Data Soft Technology
Approved By :-	
Date :-	
Date :-	

Siliguri Municipal Corporation
Commissioner

SLUM BOUNDARY OF SILIGURI MUNICIPALITY

(WARD NO.-35)

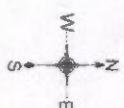


Ward No.- 24

Ward No.- 30

Ward No.- 30

G. G. Sarker
Executive Engineer
Siliguri Municipal Corporation
Siliguri

S. Siliguri
Commissioner
Siliguri Municipal Corporation

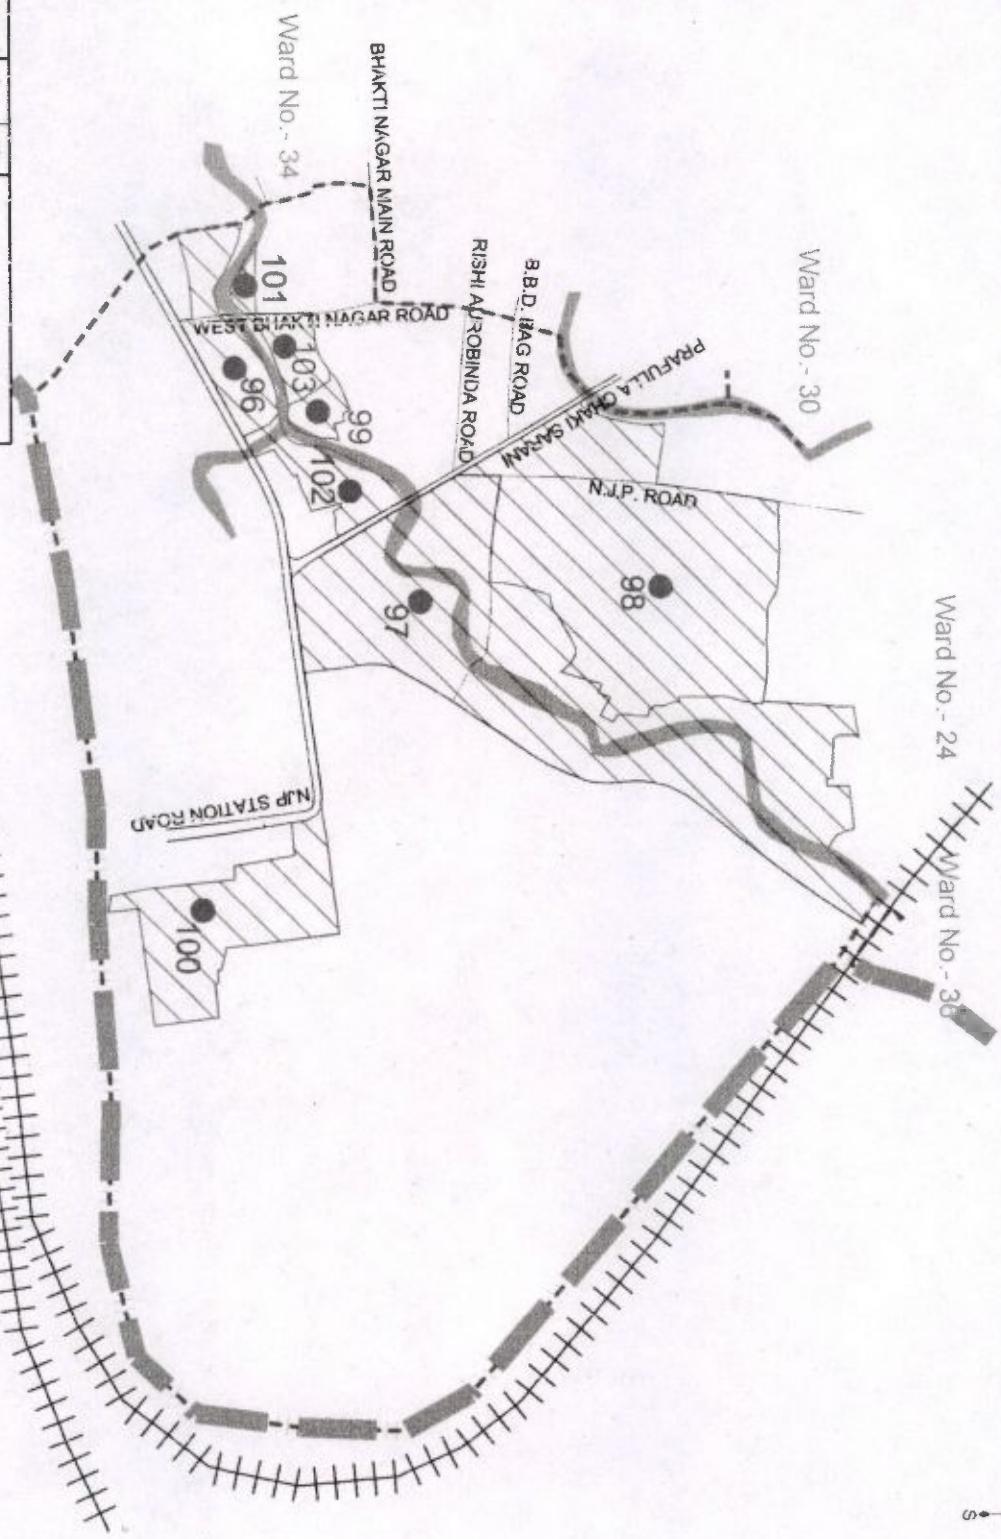

Ward	Slum	Sl.	Slum Name
No.	Code	No.	
81	96	96	Raja Hawly
82	97	97	Sahid Colony-A
83	98	98	Sahid Colony-B
84	99	99	Sahid Colony-C
85	100	100	Ramnagar
86	101	101	Bhaktinagar-A
87	102	102	Sahid Colony-D
89	103	103	Bhaktinagar-B

Slum location Map of
Siliguri Municipality

Prepared By:-

Data Soft Technology

Scale:



Checked By:

Drawing No.:


Date:

Approved By:

Date:

SLUM BOUNDARY OF SILIGURI MUNICIPALITY

(WARD NO - 36)

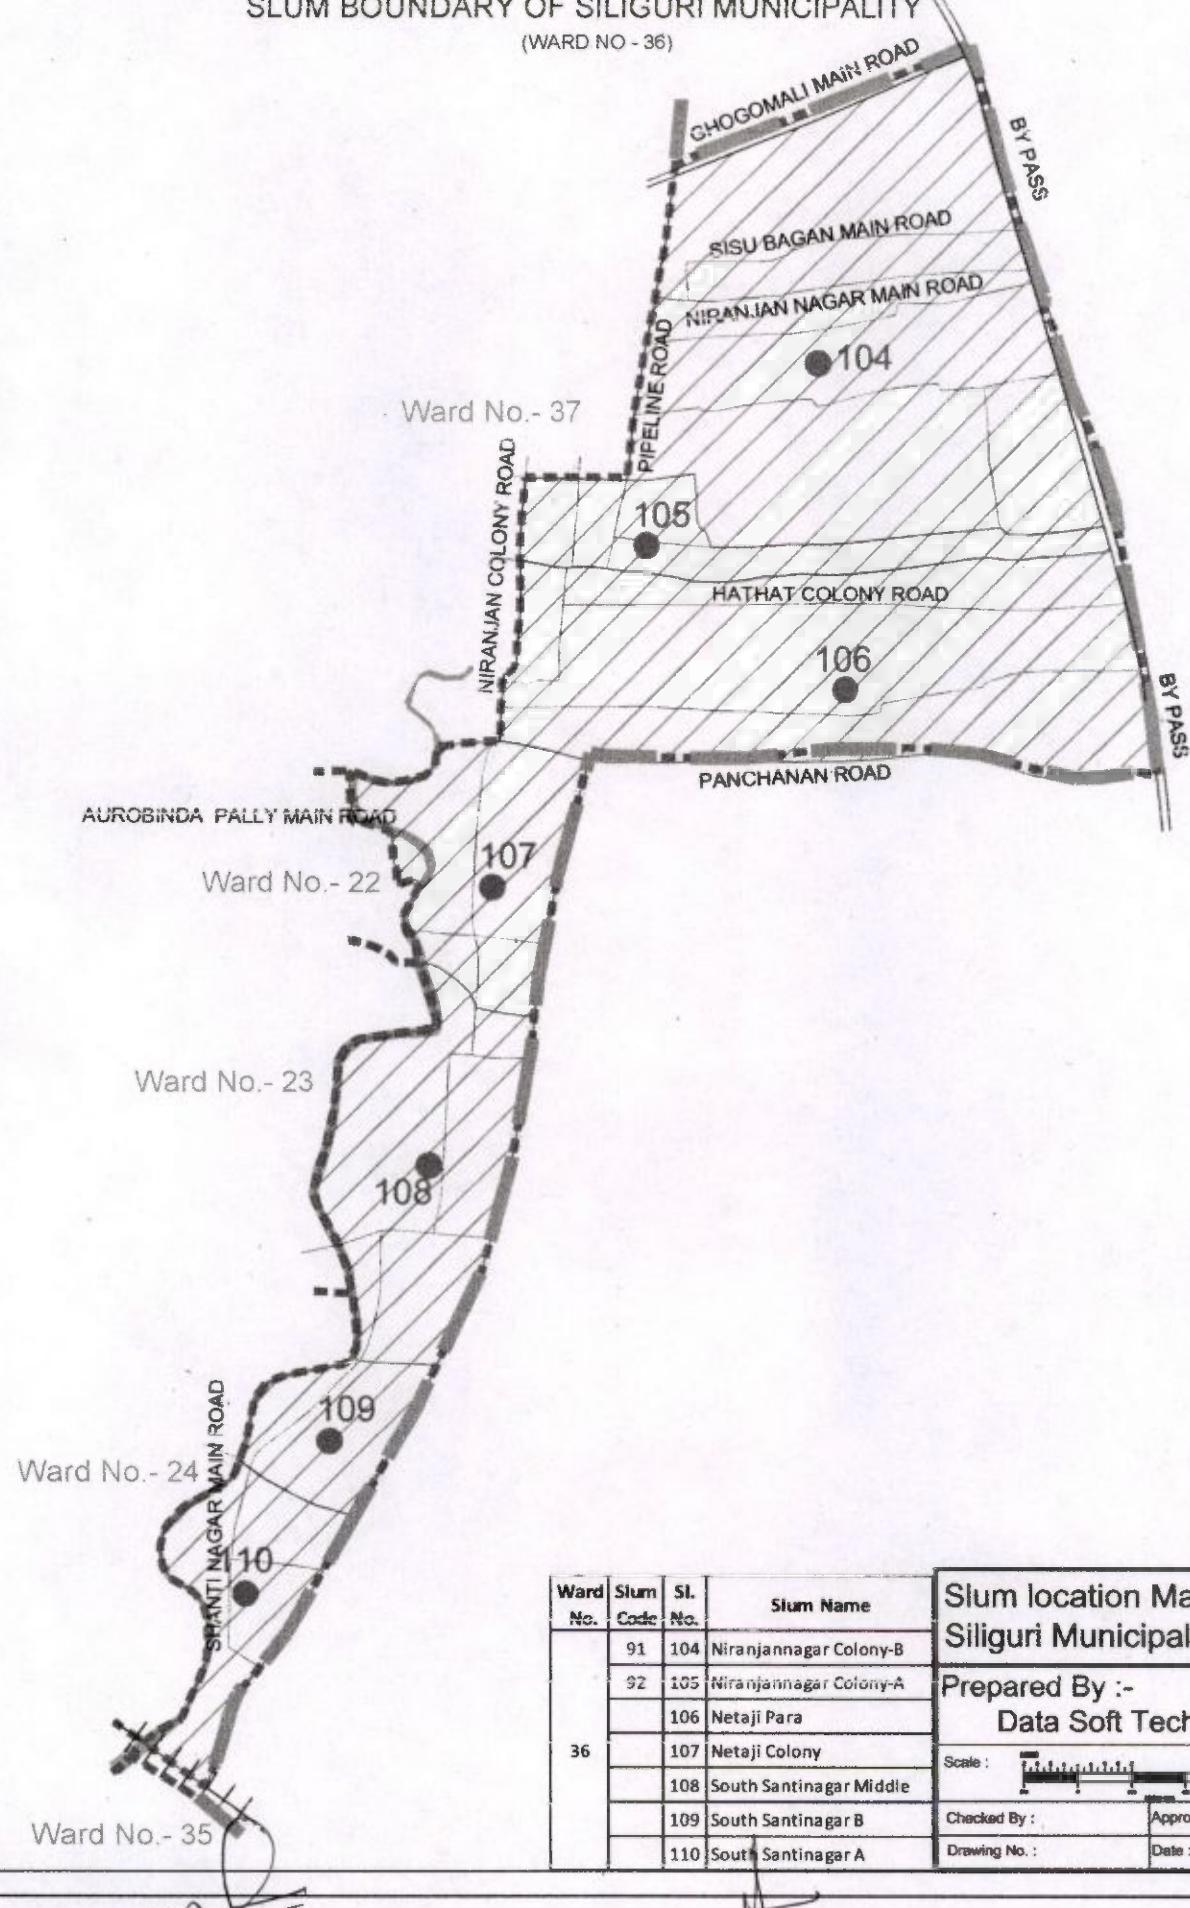

Ward No.	Slum Code	Sl. No.	Slum Name
36	91	104	Niranjannagar Colony-B
	92	105	Niranjannagar Colony-A
		106	Netaji Para
		107	Netaji Colony
		108	South Santinagar Middle
		109	South Santinagar B
		110	South Santinagar A

Slum location Map of Siliguri Municipality

Prepared By :-
Data Soft Technology

Scale :

Checked By : Approved By :
Drawing No. : Date :



P.Bose

Executive Engineer
Siliguri Municipal Corporation
Siliguri

Commissioner
Siliguri Municipal Corporation
al-

SLUM BOUNDARY OF SILIGURI MUNICIPALITY

(WARD NO - 37)

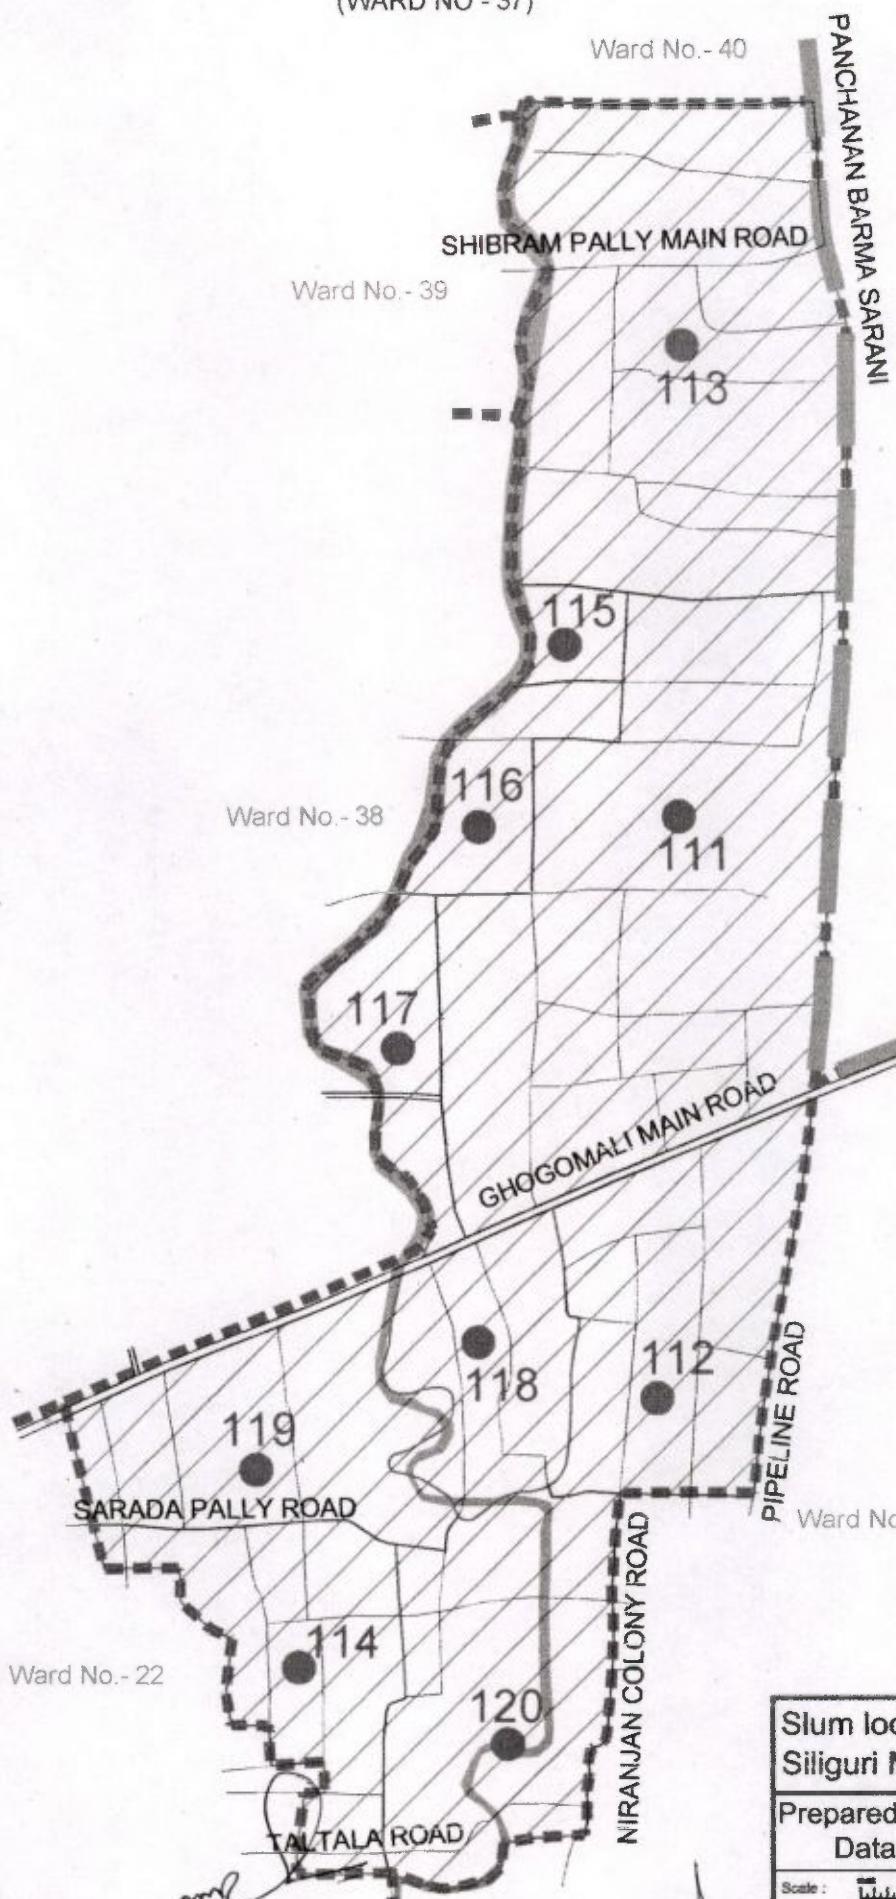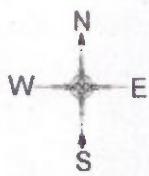

Ward No.	Slum Code	Sl. No.	Slum Name
37	96	111	Chayan Para Colony
	97	112	Niranjan Nagar Colony
	98	113	Amtaia Colony
	99	114	Netajinagar Colony
	115	115	Fei Para
	116	116	Saha Para
	117	117	Das Para
	118	118	Ghugumali Bazar
	119	119	Sarada Pally
	120	120	Niranjan Nagar Colony

P. Basu
Executive Engineer
Siliguri Municipal Corporation


Siliguri Municipal Corporation

Slum location Map of Siliguri Municipality	
Prepared By :- Data Soft Technology	
Scale :	
Checked By :	Approved By :
Drawing No. :	Date :

Commissioner

SLUM - BOUNDARY OF SILIGURI MUNICIPALITY


(WARD NO - 38)

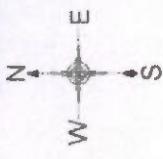

G. D.
am J.

Executive Engineer
Siliguri Municipal Corporation
Siliguri

Commissioner
Siliguri Municipal Corporation
Siliguri

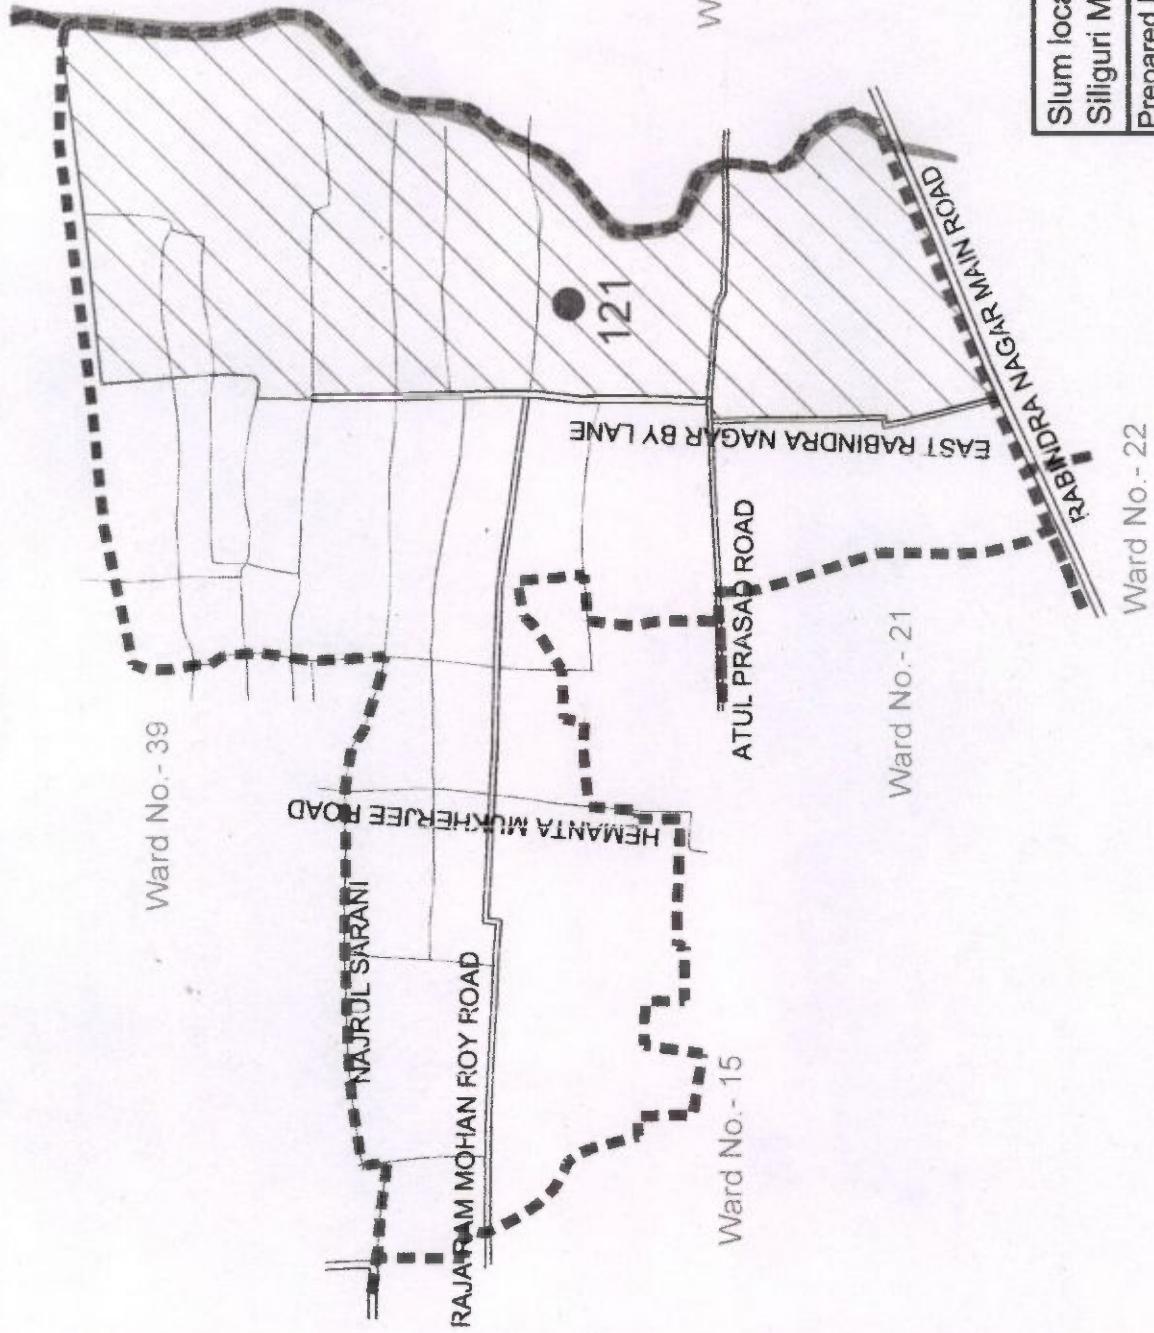

Slum location Map of
Siliguri Municipality


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Data Soft Technology

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Checked By :	Approved By :
Date :	
Drawing No. :	

Ward No.	Slum Code No.	Slum Name
38	100	121 Sukantanagar Colony

SLUM BOUNDARY OF SILIGURI MUNICIPALITY

(WARD NO - 39)

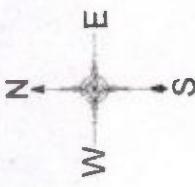

Ward No. - 40

MEGHLAL SARANI

RABINDRA SARANI

Ward No. 13

Ward No. - 14

Ward No. - 15

SHIBRAM PALLY MAIN ROAD

122

SRIMA SARANI

NATURUT SARANI

HAIIDAR PARA MAIN ROAD

3

Executive Engineer
Municipal Corp
Siliguri

Ward No. - 37

Comptroller
Siliguri M.

Slum location Map of
Siliguri Municipality

Prepared By :-
Data Soft Technology

Scale :
Checked By :
Drawing No. :
Date :

Ward No.	Slum Code	Sl. No.	Slum Name
39	101	122	Shivram pally


SLI BOUNDARY OF SILIGURI MUNICIPALITY

(WARD NO - 40)

G. Basu

Executive Engineer
Siliguri Municipal Corporation
Siliguri

Commissioner
Siliguri Municipal Corporation

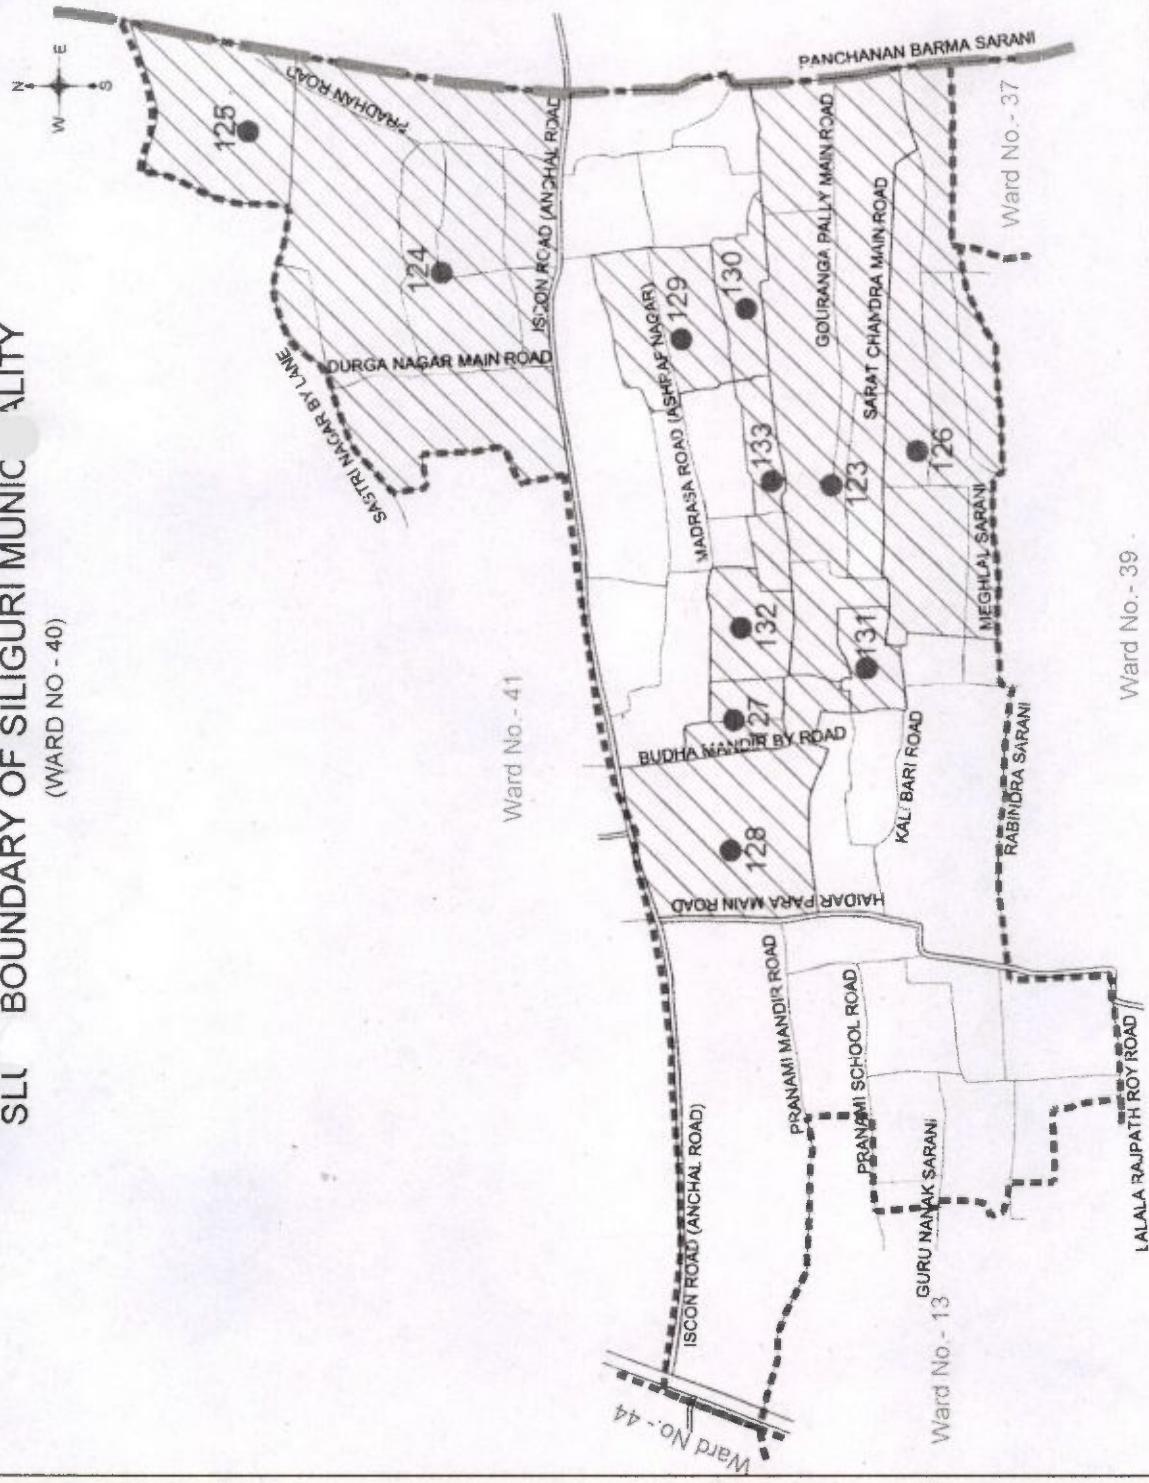

Ward No.	Slum Code No.	Slum Name
10.2	123	Sarabaliy
10.1	124	Kshudiram South North Etc's Sai
10.1	125	Durga Nagar
10.5	126	Stuti Nagally colony
10.6	127	Asia Nagar
10.7	128	Harekrishna Colony
40	129	Jyotinagar Colony
10.9	130	Subha shabu-A
11.0	131	Subha shabu-B-South Ektasai
11.1	132	Subha shabu-C-Pradhan More Ektasai
	133	Dakshin Ektashil

Slum Location Map of Siliguri Municipality	
Prepared By :- Data Soft Technology	
Checked By :	Approved By :
Drawing No. :	Date :

UM BOUNDARY OF SILIGURI MUNICIPAL CORPORATION

(WARD NO - 41)


Ward No. - 42



G. G. S.
mm

Executive Engineer
Siliguri Municipal Corporation
Siliguri

Commissioner
Siliguri Municipal Corporation

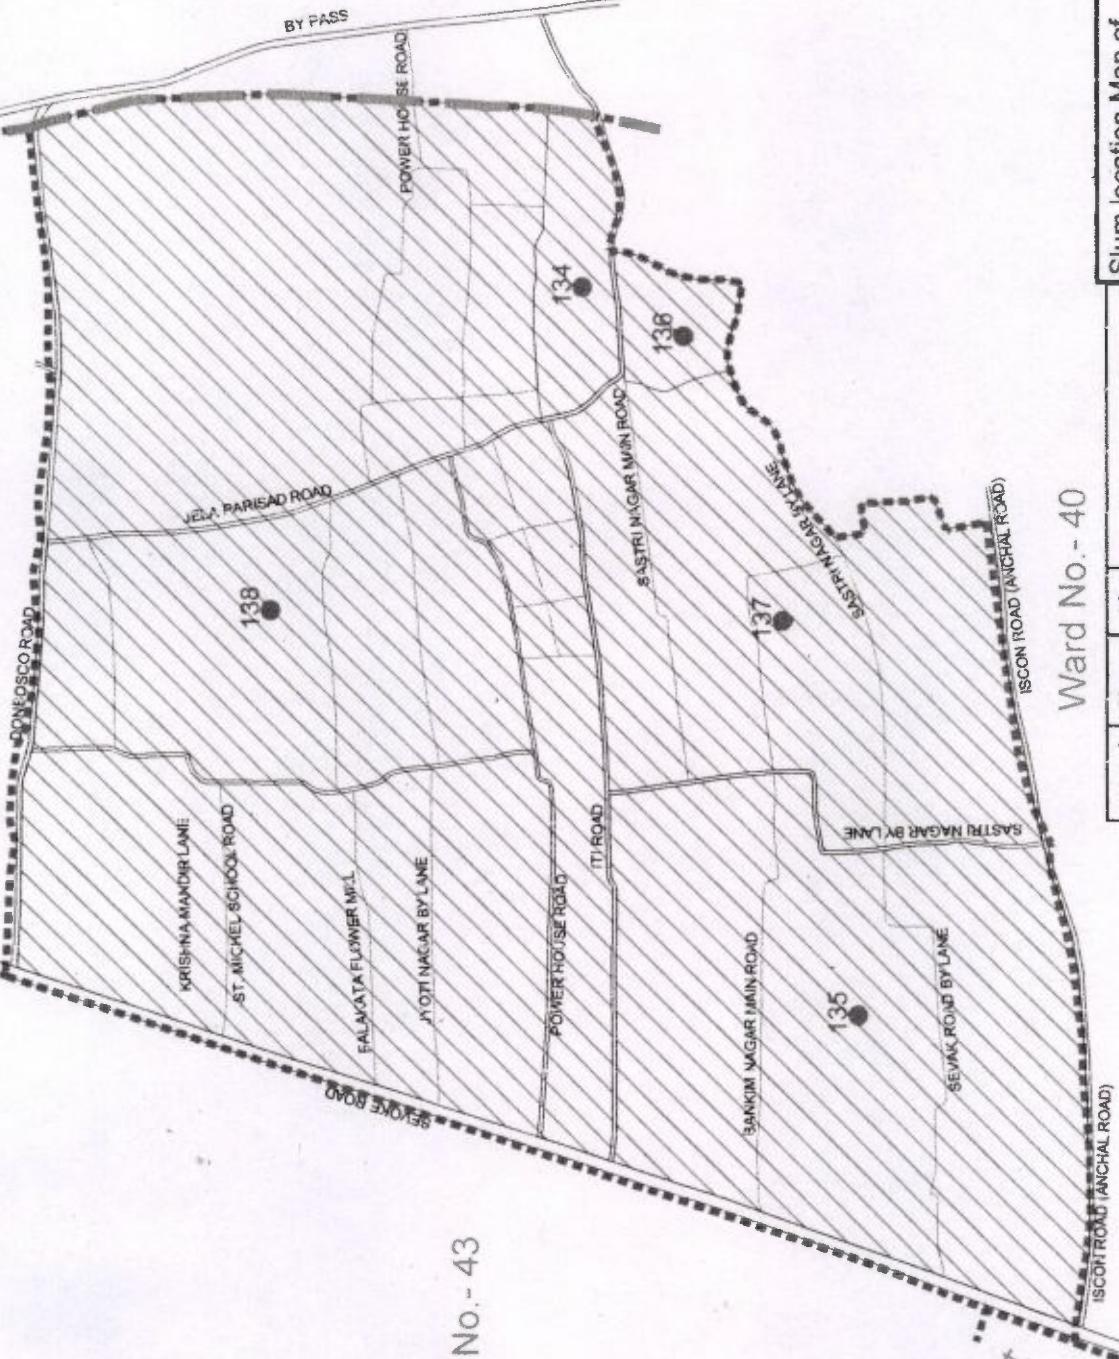

Ward No. - 40

Slum location Map of Siliguri Municipality			
Ward No.	Slum Code No.	Sl. No.	Slum Name
41	112	134	Balkuntha Pally
	113	135	Jyotinagar Colony
	114	136	Amtala Colony
	115	137	Shatrinagar Colony
	116	138	Bankimnagar

Prepared By :- Data Soft Technology
Scale : 1:10000
Approved By :
Drawing No. : Date :


Slum Location Map of
 Siliguri Municipal Corporation
 Prepared By :-
 Datta Soft Technology
 Sliguri Municipal Corporation

G. G. S.
and D.

Executive Engineer
 Siliguri Municipal Corporation
 Prepared By :-
 Datta Soft Technology


Commissioner
 Siliguri Municipal Corporation

Ward No.	Slum No.	Slum Name
42	152	Pramod Nagar Colony
	151	Sorjil Palli
	150	Nimbu Base
	149	Sarba Palli
	148	Chayen Para
	147	Nekai Nagari
	146	Bhaba Sinchu Colony
	145	Sahibpur North East
	144	Panchanan Palli
	143	Vivekananda Nagar
	142	Kamala Nagar
	141	Shant Para
	140	Blupendranagar
	139	Roy Colony
	138	Normal Convict School Road
41	139	Ward No. - 41

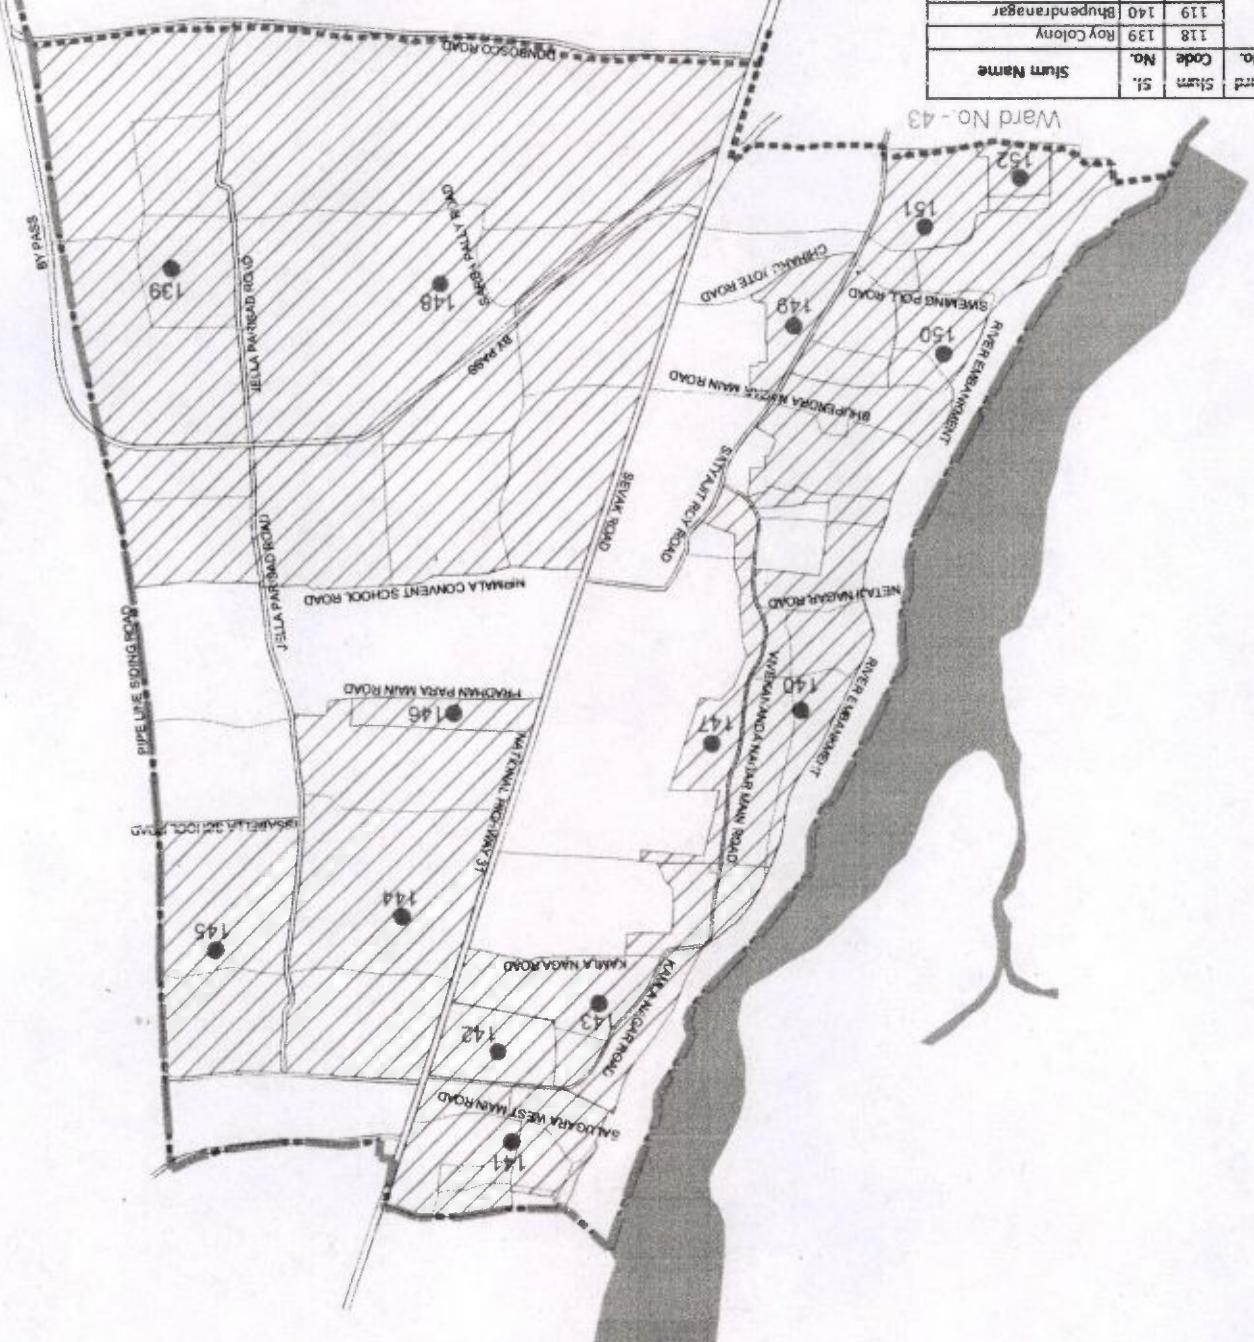

(WARD NO - 42)

SLUM BOUNDARY OF SILIGURI MUNICIPALITY

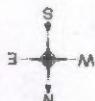



Siliguri Municipal Corporation
Commissioner

Siliguri Municipal Corporation
Executive Engineer

Siliguri Municipality
Slum Location Map of
Data Soft Technology
Prepared By :-


Ward No.	Slum No.	Slum Name	Slum No.	Code No.	Slum No.
43	128	160	160	160	Manepuri Bastee
	127	159			Sahid Nagar
	126	158			Gandhinagar
	125	157			Praakashnagar
	124	156			Paswan Bastee
	123	155			Dada Bhai Colony
	122	154			New Praakashnagar
	121	153			Lower Beldumuda

SLUM BOUNDARY OF SILIGURI MUNICIPALITY
(WARD NO - 43)

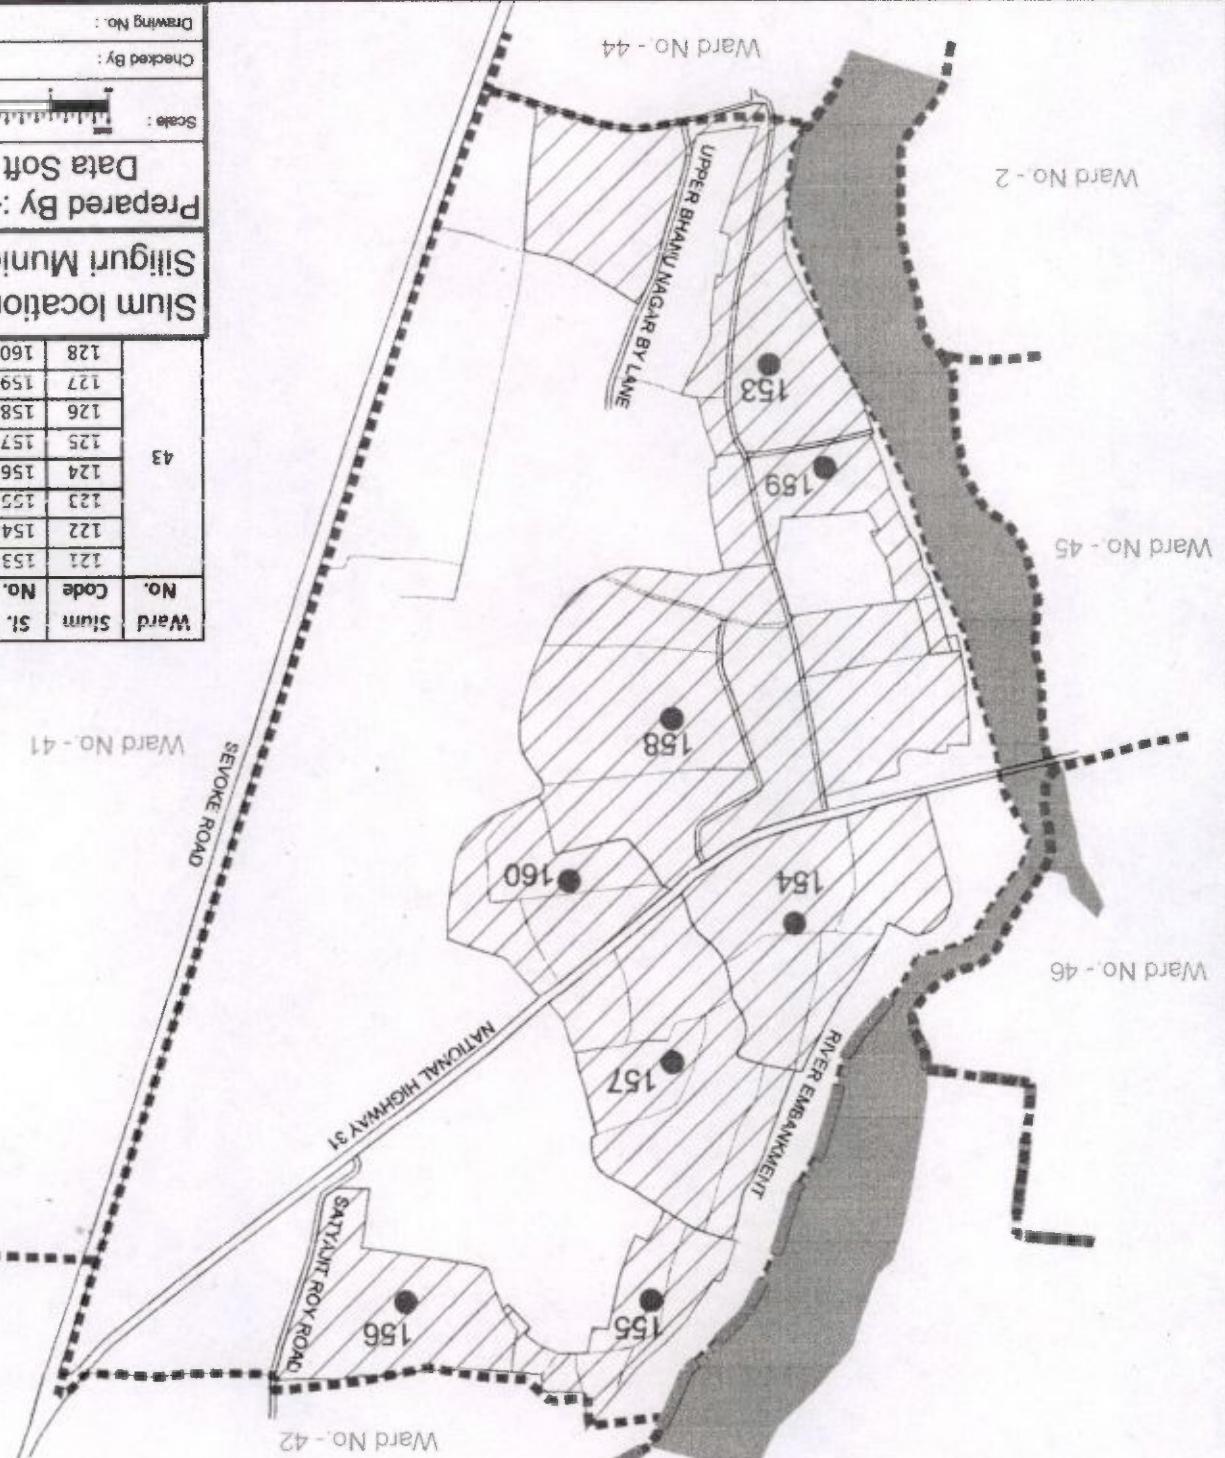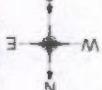

SLUM BOUNDARY OF SILIGURI MUNICIPALITY

(WARD NO - 44)

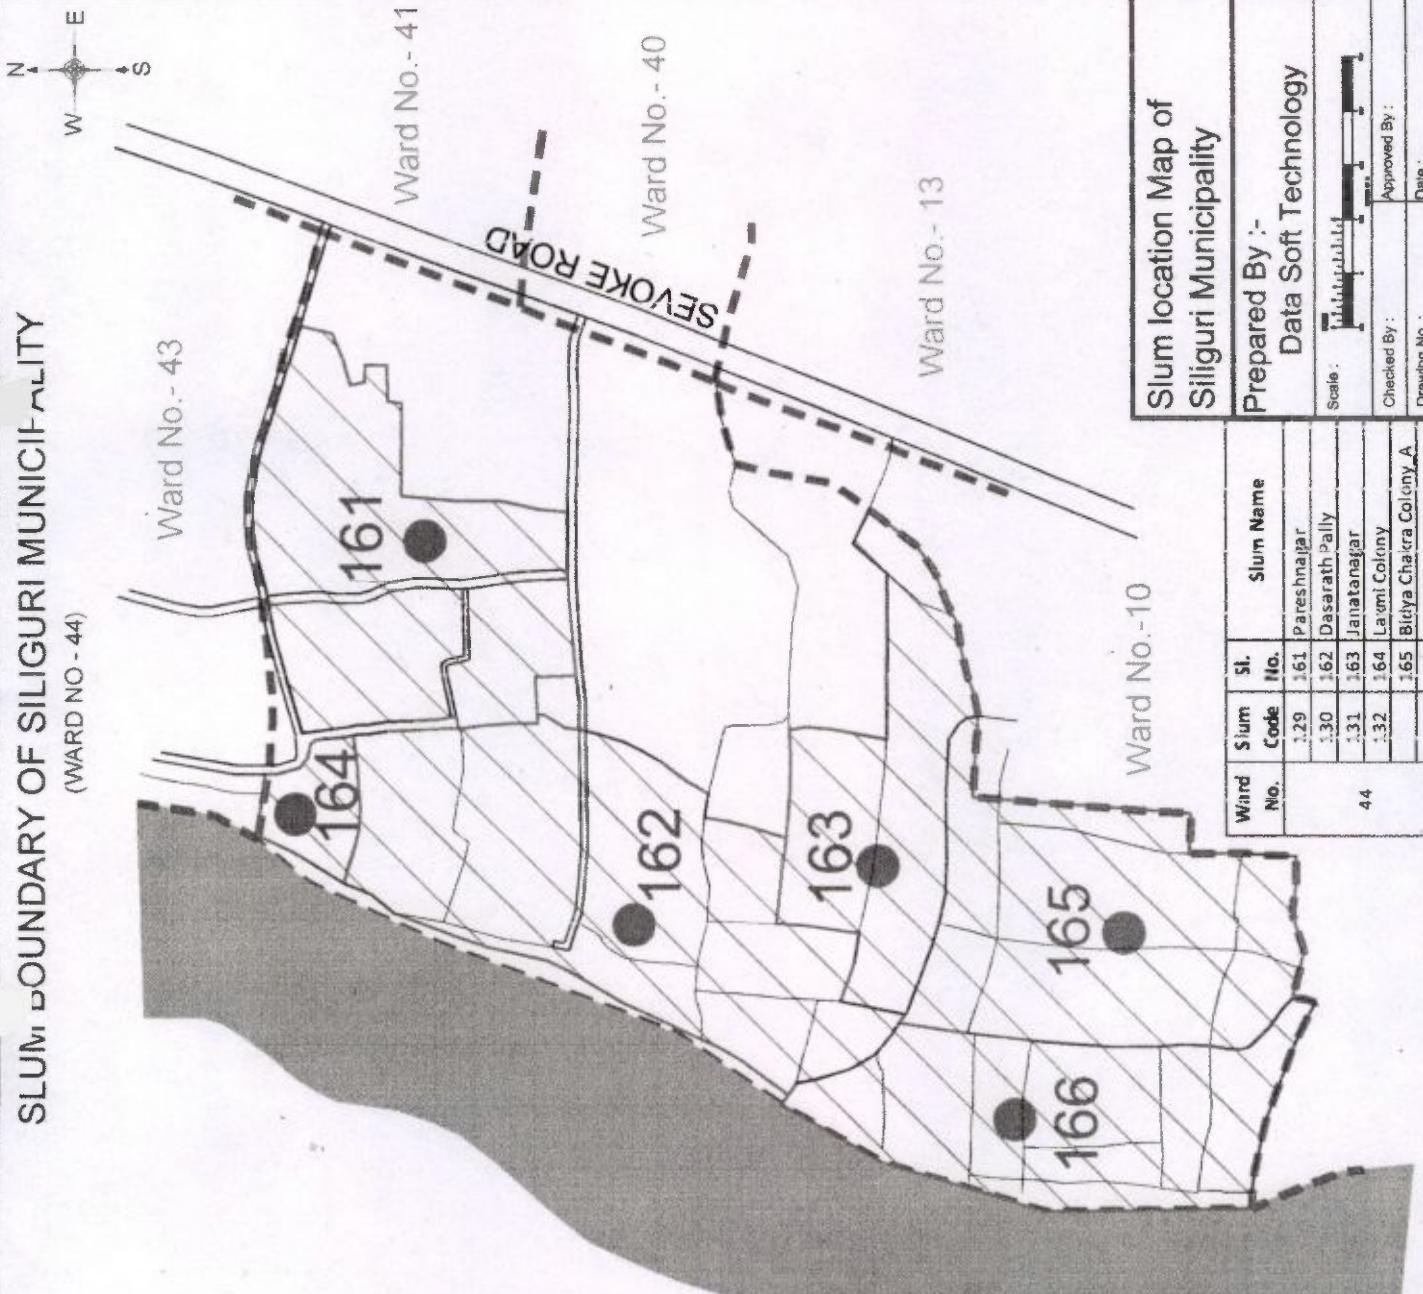

Executive Engineer
Siliguri Municipal Corpora
Siliguri

Commissioner

Siliguri Municipal Corpora
Siliguri

Slum location Map of
Siliguri Municipality

Prepared By :-
Data Soft Technology

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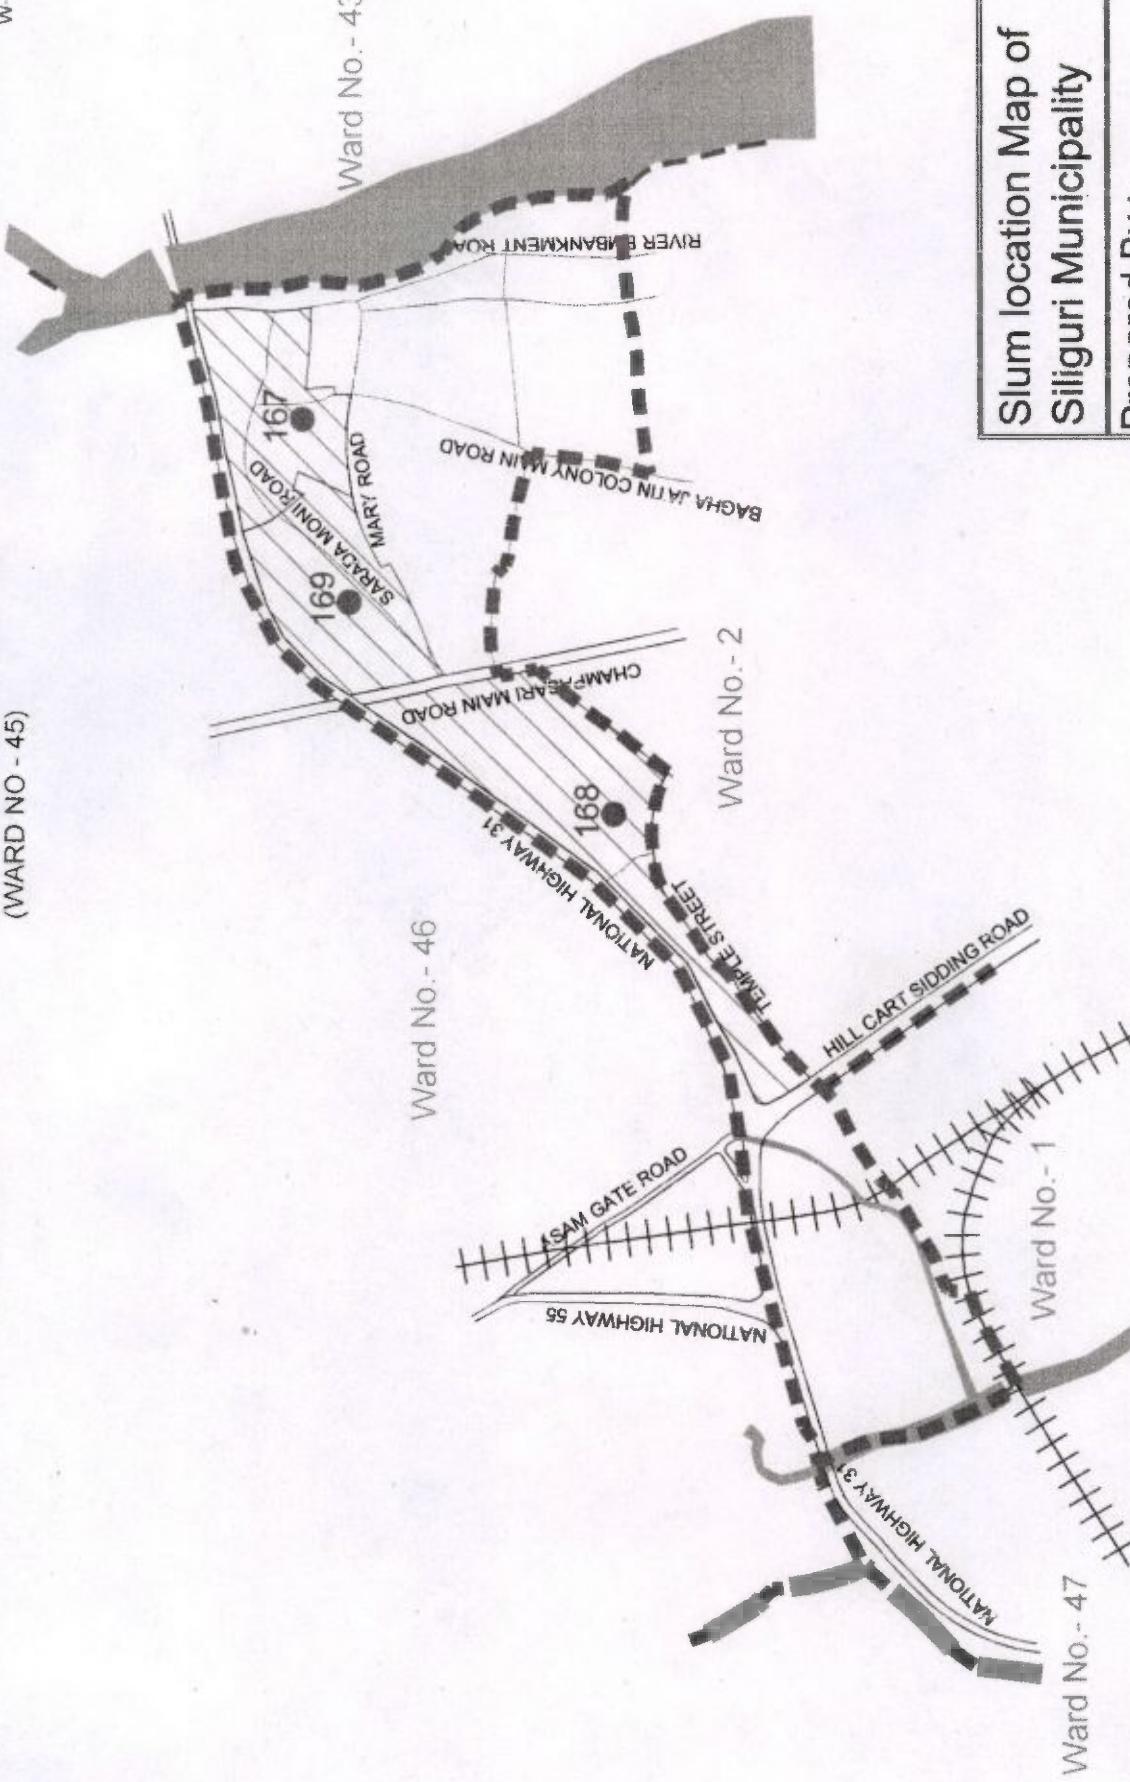
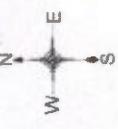
Approved By :

Date :

Ward No.	Slum Code No.	Sl. No.	Slum Name
129	161	Pareshnagar	
130	162	Dasarath Pally	
131	163	Janatanagar	
44	164	Lavni Colony	
	165	Bidya Chakra Colony A	
	166	Bidya Chakra Colony B	

SLUM BOUNDARY OF SILIGURI MUNICIPALITY

(WARD NO - 45)



**Slum location Map of
Siliguri Municipality**

Prepared By :-
Data Soft Technology

Scale :



Checked By :
Commissioner
Drawing No. :
Date :

Siliguri Municipal Corporation
Siliguri

Executive Engineer
Siliguri Municipal Corporation
Siliguri

Ward No.	Slum Code	Sl. No.	Slum Name
45	133	167	Baghajatin Colony
	134	168	Durgaguri Colony
	135	169	North Baghajatin Colony

SLUM BOUNDARY OF SILIGURI MUNICIPALITY

(WARD NO - 46)



**Slum location Map of
Siliguri Municipality**

**Prepared By :-
Data Soft Technology**

Scale :

Checked By : Approved By :

Drawing No. : Date :



Ward No.	Slum Code	Sl. No.	Slum Name
136	170	Shibnagar Colony	
137	171	Ganesh Ghosh Colony	
138	172	Rajibnagar Colony	
139	173	Netaji Nagar Colony	
140	174	Samar Nagar Colony	
141	175	Satyjit Nagar Colony	
142	176	Pukai Jote	
143	177	Naya Bastee	
144	178	Ananda Mayee Colony	
145	179	Jyoti Nagar Colony	
146	180	Promad Nagar	
147	181	Dakni Kata	
148	182	Narmada Bagan (East)	
149	183	Gobara Bastee	
	184	Ujamu Shib Nagar	
	185	Green Park	
	186	New Pukai Jote	
	187	Bebai Buste	
	188	North Mallaguri	
	189	Narmada Bagan (South)	
	190	Pabitra Nagar	
	191	New Indira Pally	
	192	Utpal Nagar	

Executive Engineer
Siliguri Municipal Corporation
Siliguri

**Commissioner
Siliguri Municipal Corporation**

SLUM BOUNDARY OF SILIGURI MUNICIPALITY

(WARD NO - 47)

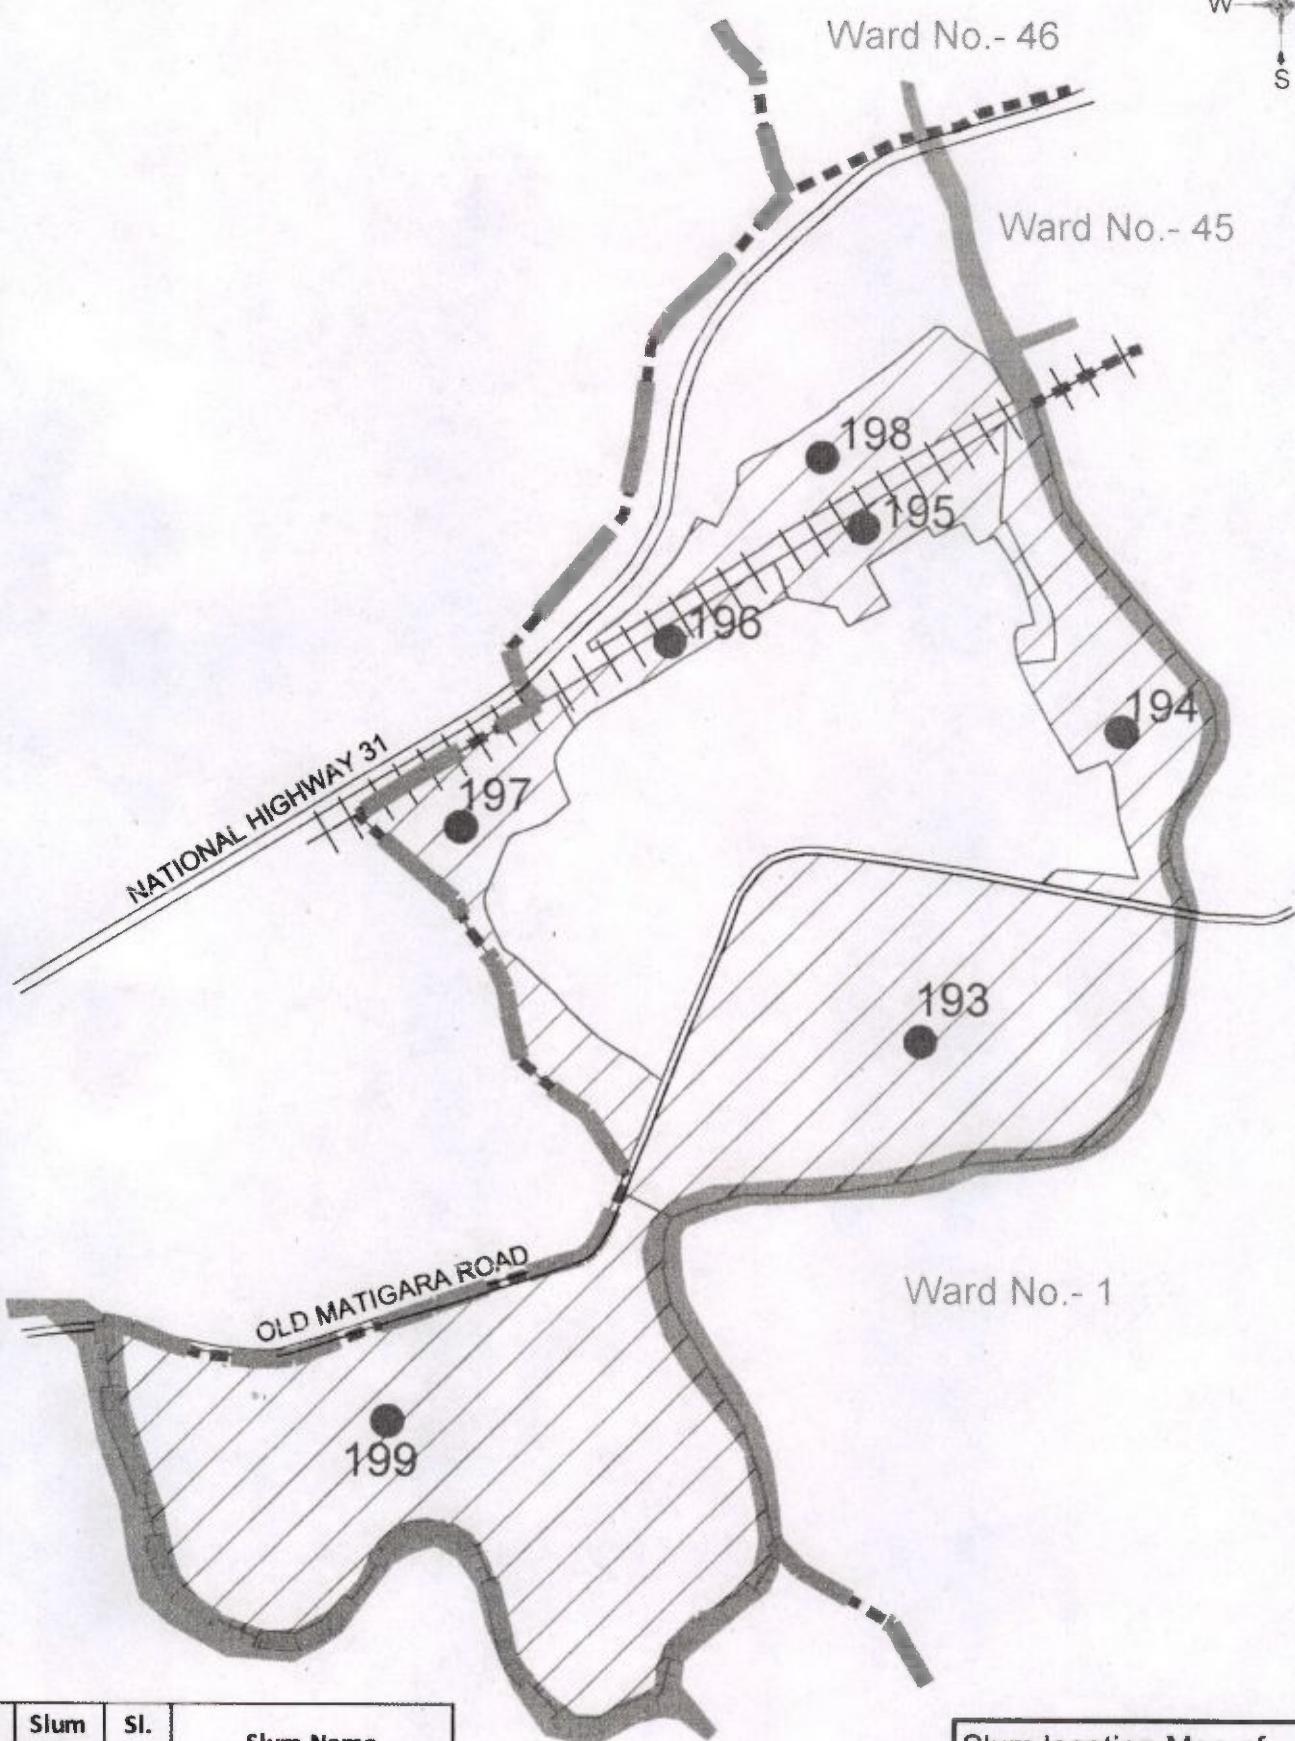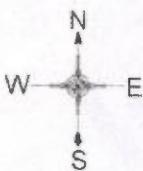

Ward No.	Slum Code	Sl. No.	Slum Name
47	150	193	Pati Colony
	151	194	Ram Krishna Nagar A
	195	195	Ram Krishna Nagar B
	196	196	Ram Krishna Nagar C
	152	197	Maha Maya Colony
	153	198	Promad Nagar Colony
	154	199	New Colony

Slum location Map of Siliguri Municipality
Prepared By :-
Data Soft Technology
Scale :
Checked By : Commissioner
Drawn By : Siliguri Municipal Corporation

Executive Engineer
Siliguri Municipal Corporation
Siliguri